GENERAL NOTES

- 1. SEE FINISH SCHEDULE / I.D. DRAWINGS FOR INFORMATION ON INTERIOR FINISHES. INTERIOR FINISHES ARE DESIGNATED BY;
- 2. ATTACH TABLE TOPS TO BASES PER MANUFACTURER'S REQUIREMENTS / INSTRUCTIONS.
- 3. RESTROOM VESTIBULE ELEVATIONS ARE SHOWN ON SHEET <u>ID2.0.</u>
- 4. RESTROOM ELEVATIONS ARE SHOWN ON SHEET A7.0.
- 5. WORKSTATION & EMPLOYEE ROOM ELEVATIONS ARE SHOWN ON SHEET K2.2.
- 6. KITCHEN ELEVATIONS ARE SHOWN ON SHEET K2.0 & K2.1.
- 7. ALL EXPOSED FINISH CORNERS AND SEAMS REQUIRE CAULKING. IN ADDITION, BUT NOT LIMITED TO, TOP OF ALL COVE BASES, ALL FIXED EQUIPMENT, ETC. DO NOT APPLY CAULKING TO ANY V.W.C. SURFACE.
- 8. SEATING LAYOUT TO COMPLY WITH ALL APPLICABLE CODES AND ORDINANCES.
- 9. ALL DIMENSIONS ARE TO FACE OF FINISHED DRYWALL AND ARE CONSIDERED CRITICAL U.O.N. THE GENERAL CONTRACTOR SHALL VERIFY ALL DIMENSIONS WITH SHOP DRAWINGS AND PLANS AGAINST REQUIRED CLEARANCES.
- 10. IT SHALL BE THE GENERAL CONTRACTOR'S RESPONSIBILITY TO VERIFY ALL QUANTITIES BEFORE ORDERING AND INSTALLING MATERIAL.
- 11. SEE DETAIL SHEETS FOR BLOCKING AT COUNTER TOPS.
- 12. FOR CORE DRILLED TABLE BASES, SEE DETAIL 10/ID3.1.
- 13. PROVIDE 2X BLOCKING AT FRAMED WALLS FOR BOOTH ATTACHMENT. VERIFY EXACT LOCATION WITH BOOTH MANUFACTURER.
- 14. CORE DRILLING DIMENSIONS ARE NOTED WITH A C.D. AND SHOULD BE VERIFIED PRIOR TO DRILLING ONCE EQUIPMENT IS ON SITE.
- 15. PROVIDE WINDOW SHADES ITEM #OF-EQ6 ON ALL WINDOWS EXCEPT CASHIER AND PICKUP PASS THRU WINDOWS. VERIFY LOCATIONS WITH CONSTRUCTION MANAGER AND OWNER AND FIELD VERIFY SIZES PRIOR TO ORDERING.



in the box® 9330 BALBOA AVENUE SAN DIEGO, CA 92123

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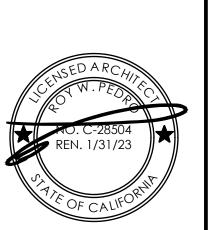
without its previous written consent.

DATES **RELEASE:** OCT. 02, 2017 P.M. UPDATES: SEPT. 27, 2019

SUBMITTAL DATE:

CONSTRUCTION:

REVISIONS





(916) 415-5358 rpedro@pmdginc.com

Roy W. Pedro, Architect

SITE INFORMATION


MK TYPE: MK9DS_MD JIB **#**: <u>4387</u>


1240 W. WOOD ST. WILLOWS, CA 95988

DRAWN BY:

PROJECT #: WFM20001.0 SCALE: 1/4" = 1'-0"

> **FURNITURE PLAN**

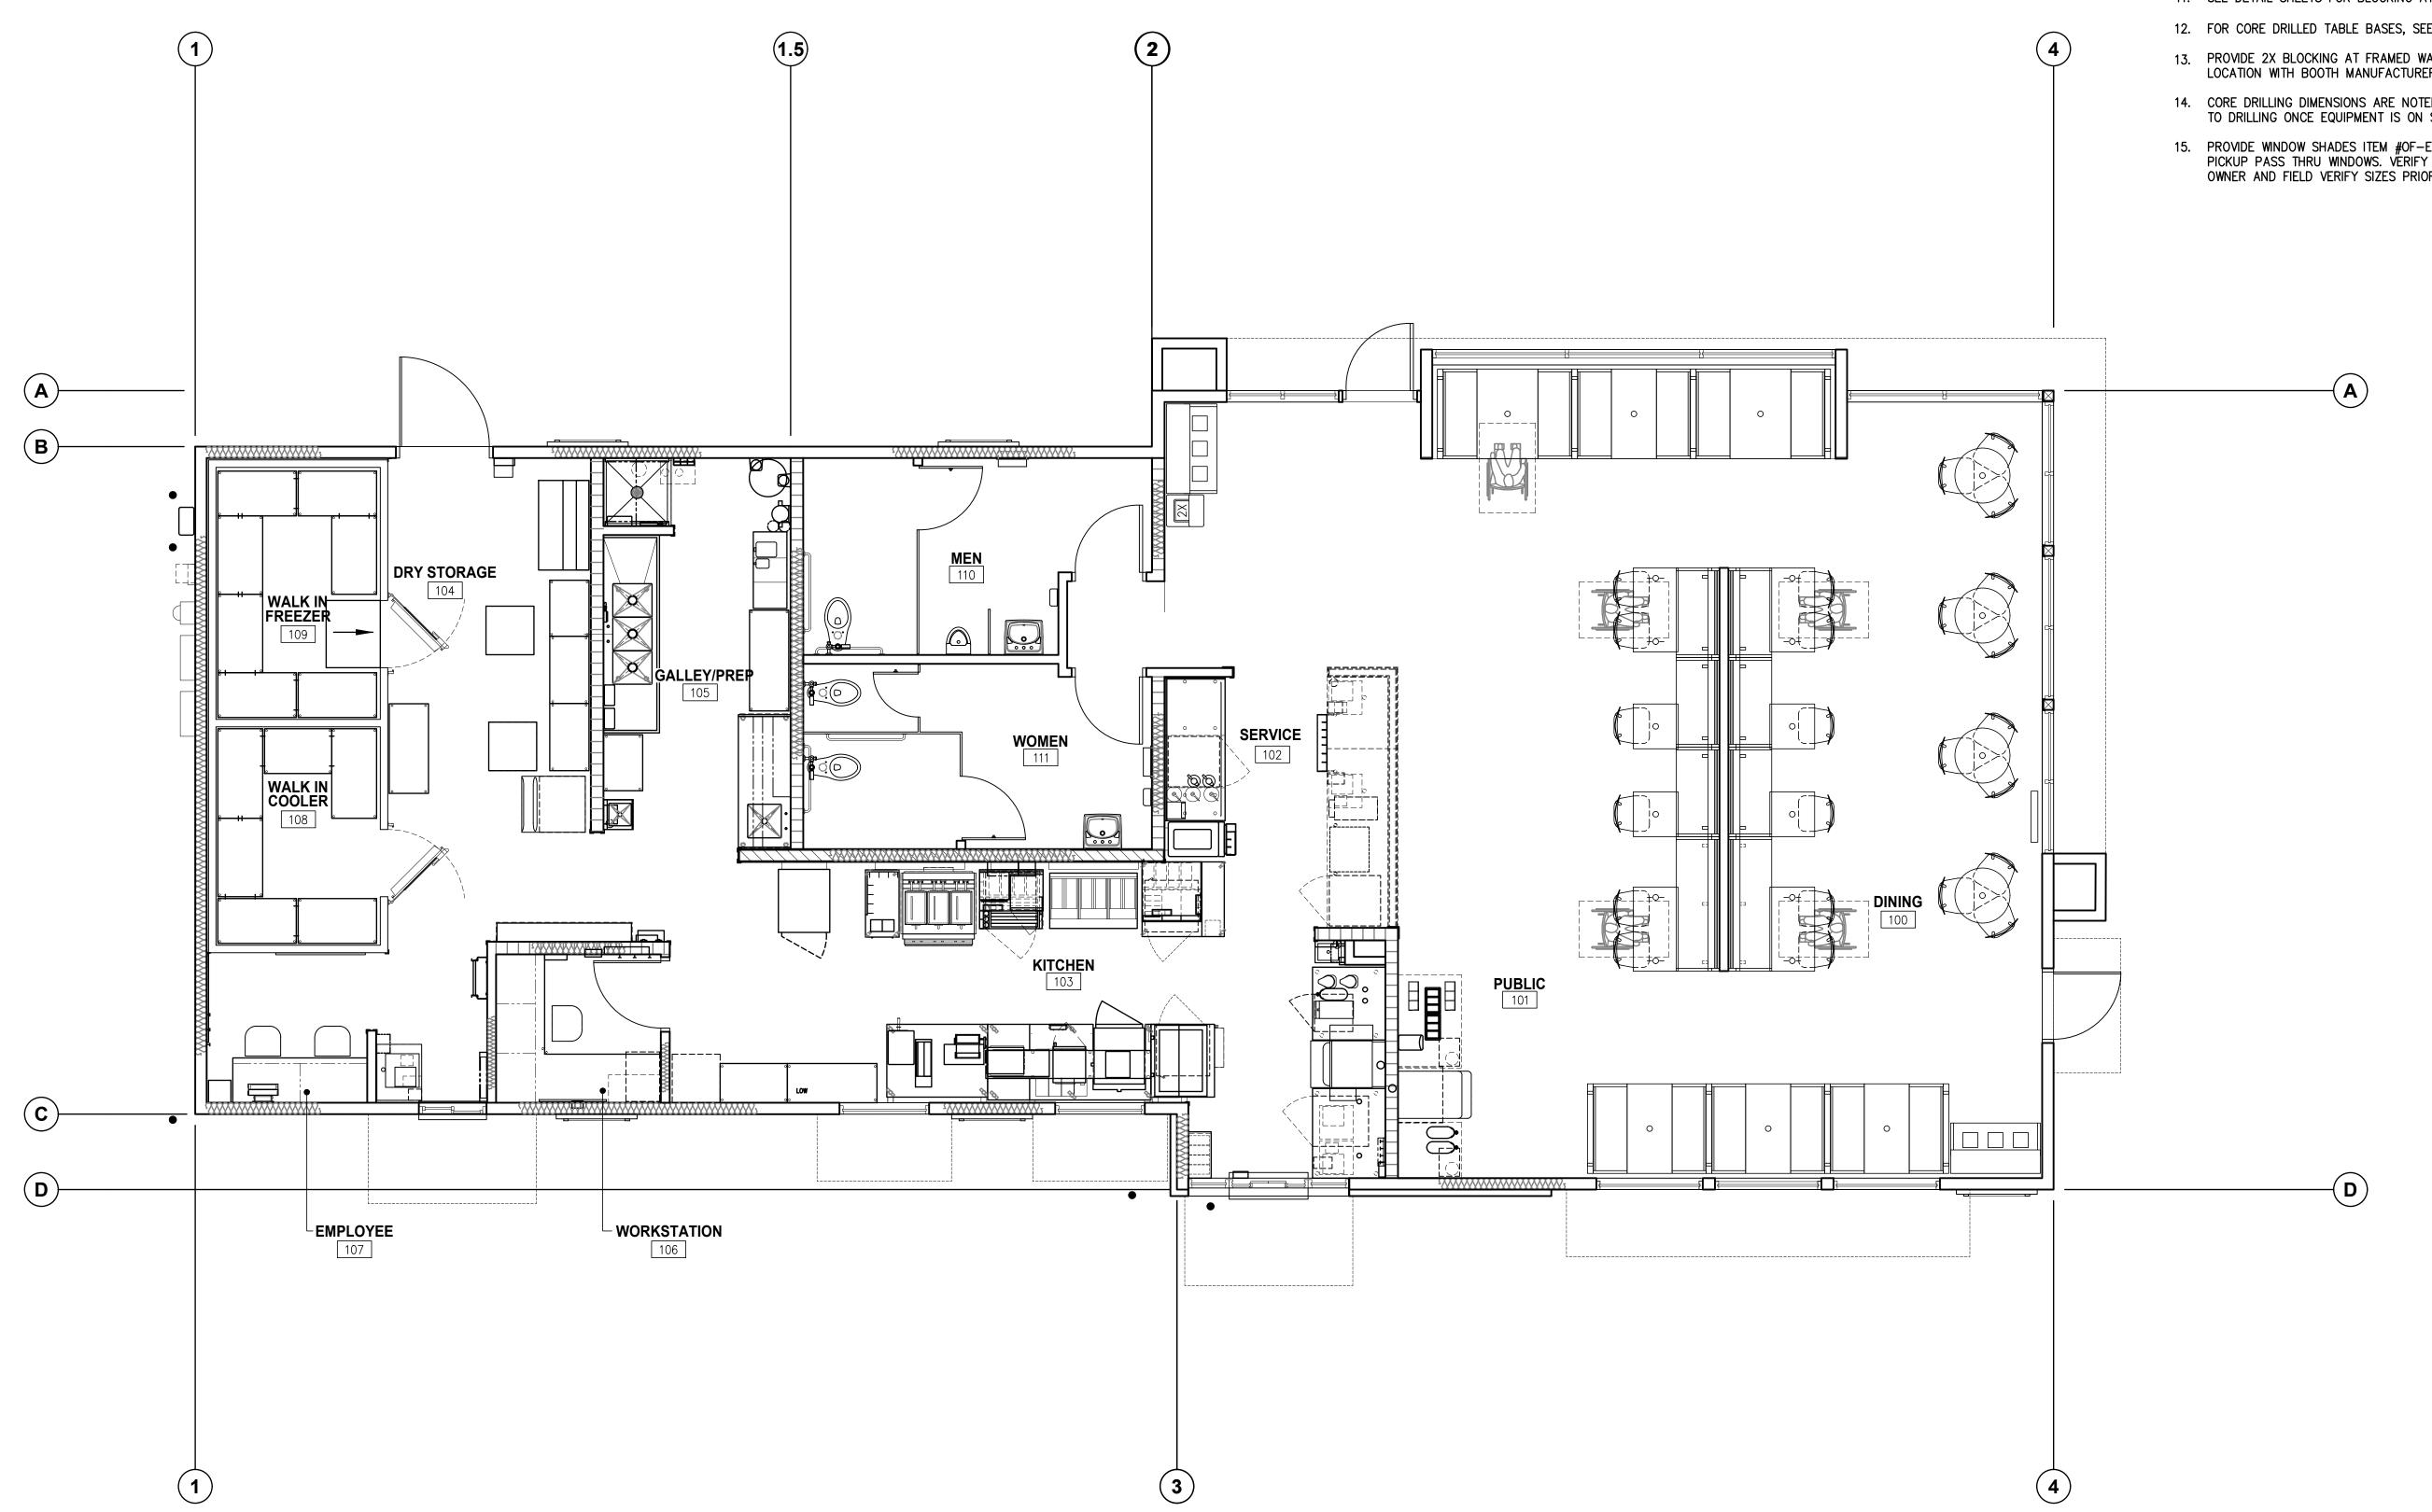

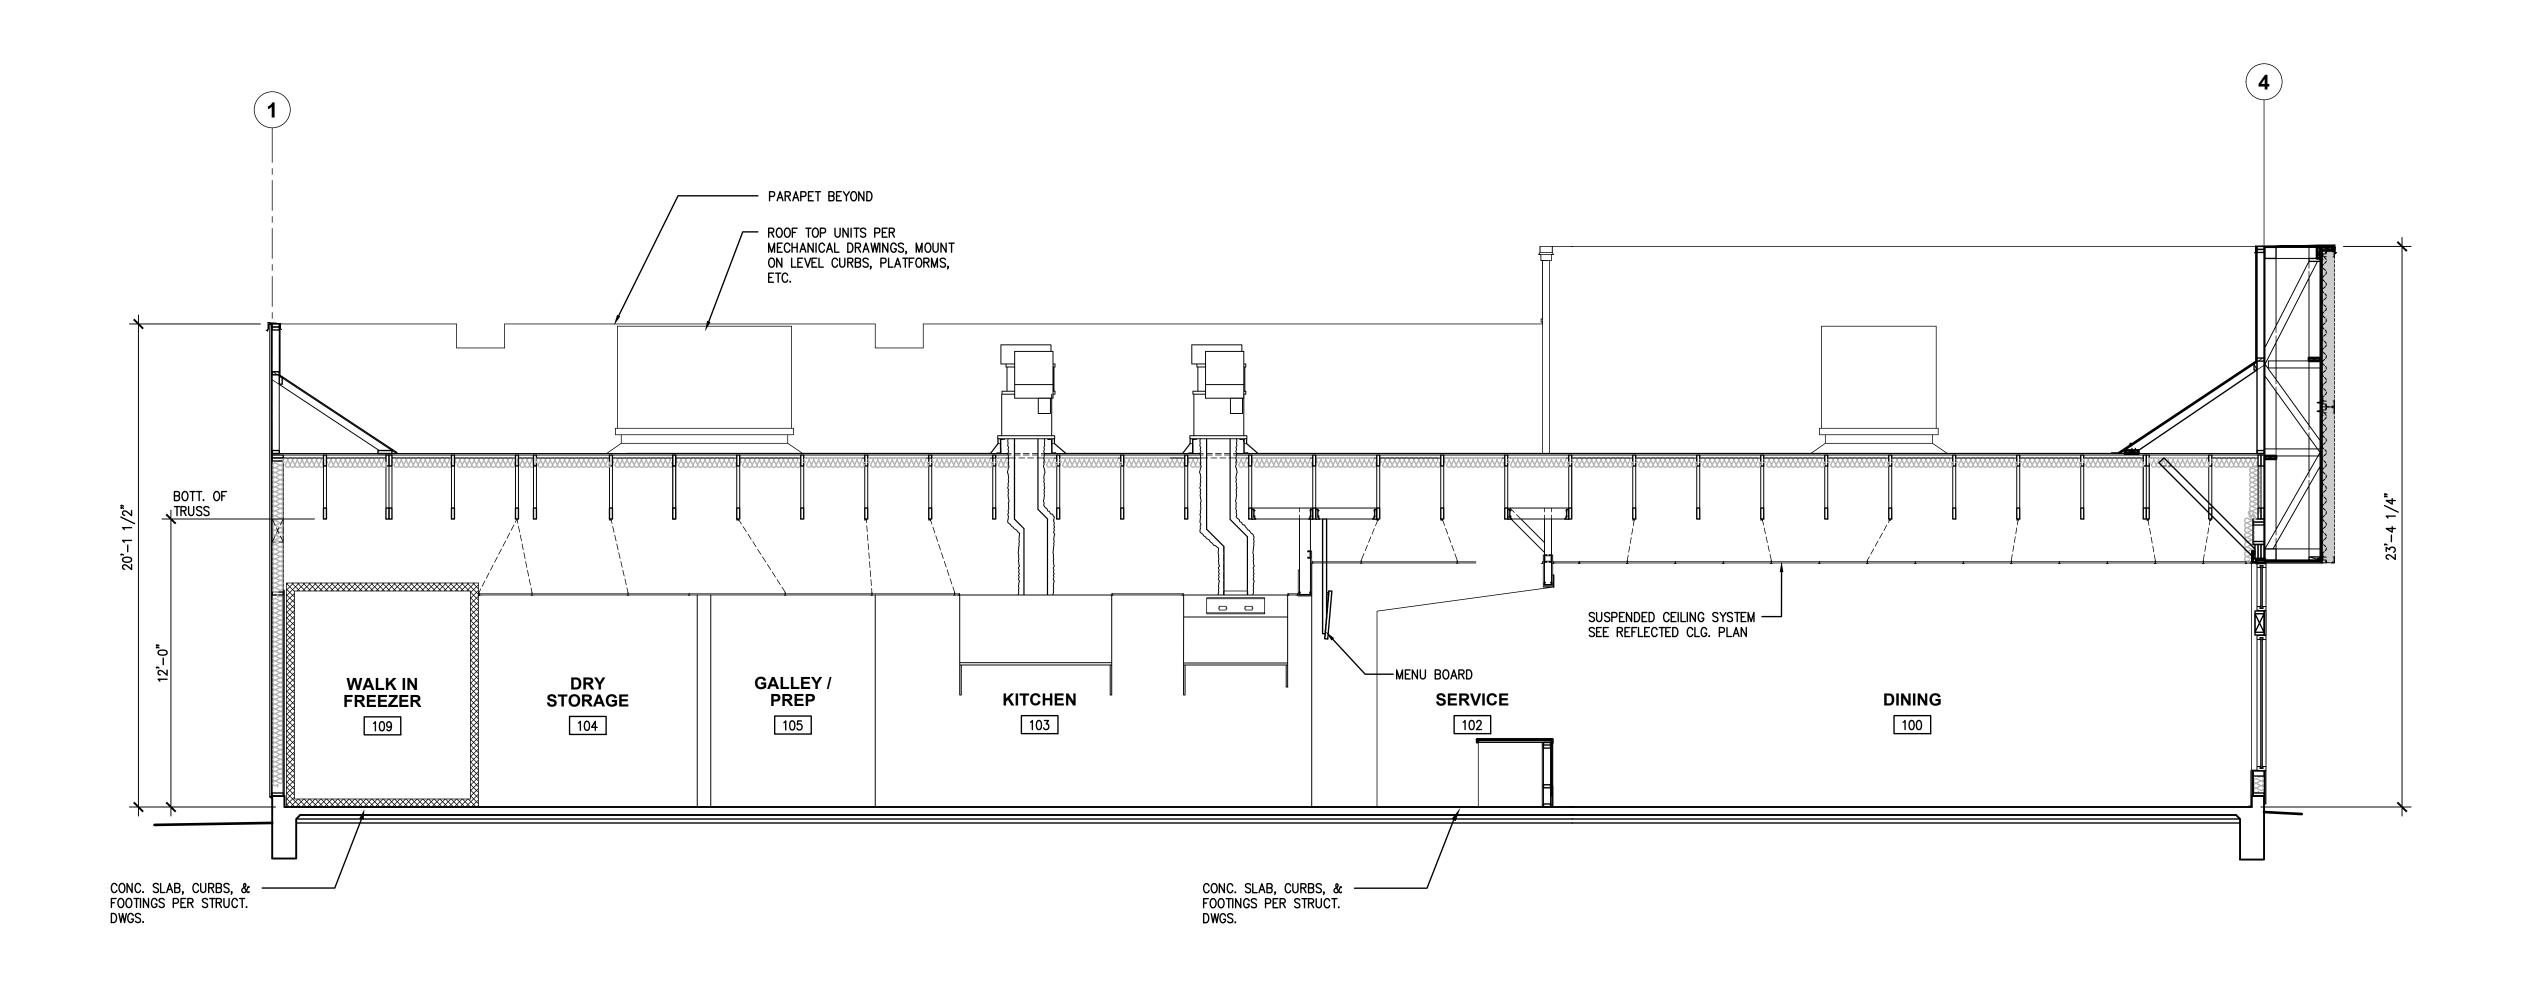

1/4" = 1'-0" PARAPET BEYOND ----PREFABRICATED ROOF TRUSSES. SEE ROOF FRAMING PLAN

Architectural Solutions Group 6930 DESTINY DRIVE SUITE 100 ROCKLIN, CA 95677

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P.M. UPDATES: <u>SEPT. 27, 2019</u>

REVISIONS

RELEASE:

SUBMITTAL DATE:

CONSTRUCTION:

OCT. 02, 2017

(916) 415-5358 rpedro@pmdginc.com Roy W. Pedro, Architect

SITE INFORMATION MK TYPE: MK9DS_MD

ADDRESS: 1240 W. WOOD ST.


WILLOWS, CA 95988


DRAWN BY: **PROJECT #**: <u>WFM20001.0</u>

SCALE: AS NOTED

BUILDING **SECTIONS**

1/4" = 1'-0"

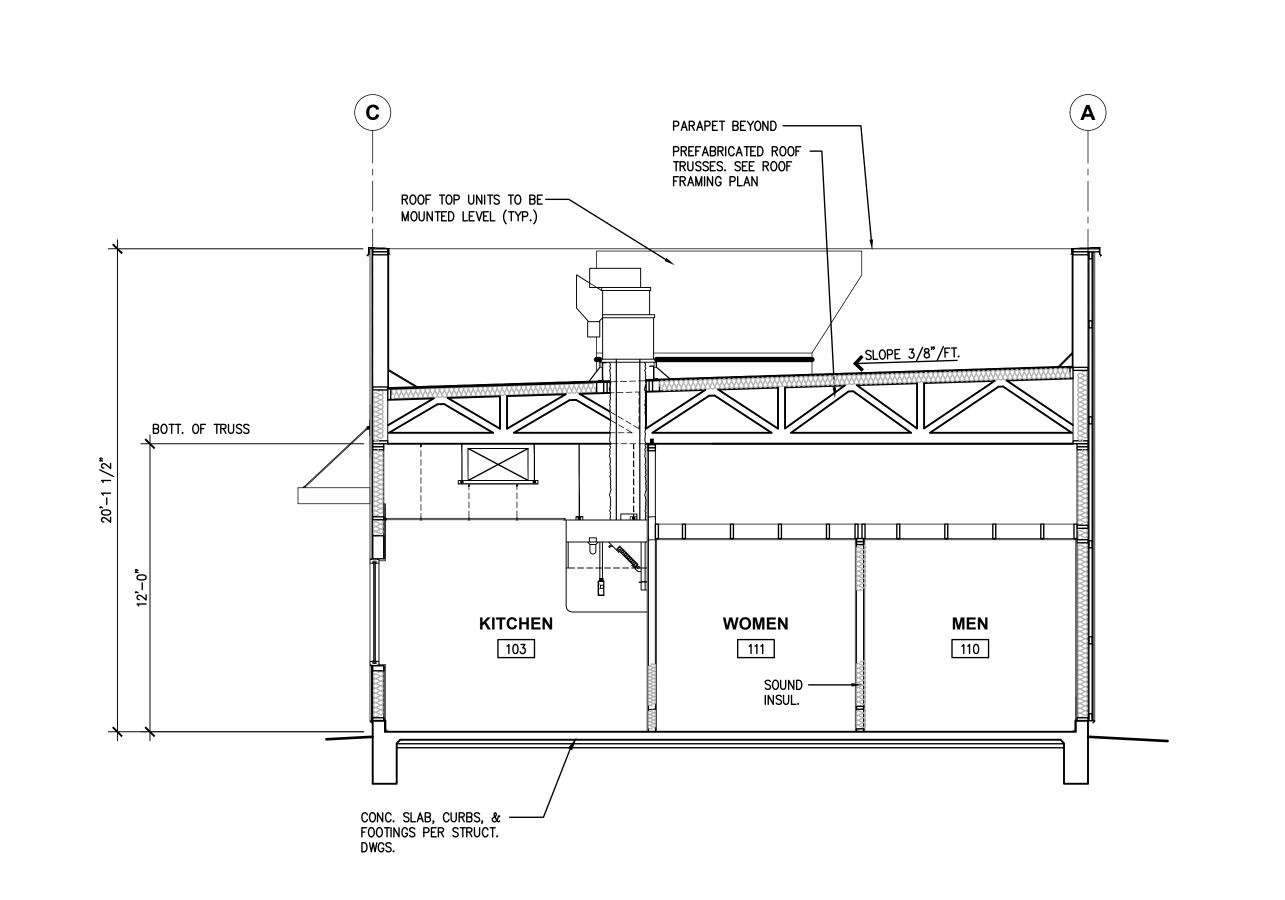

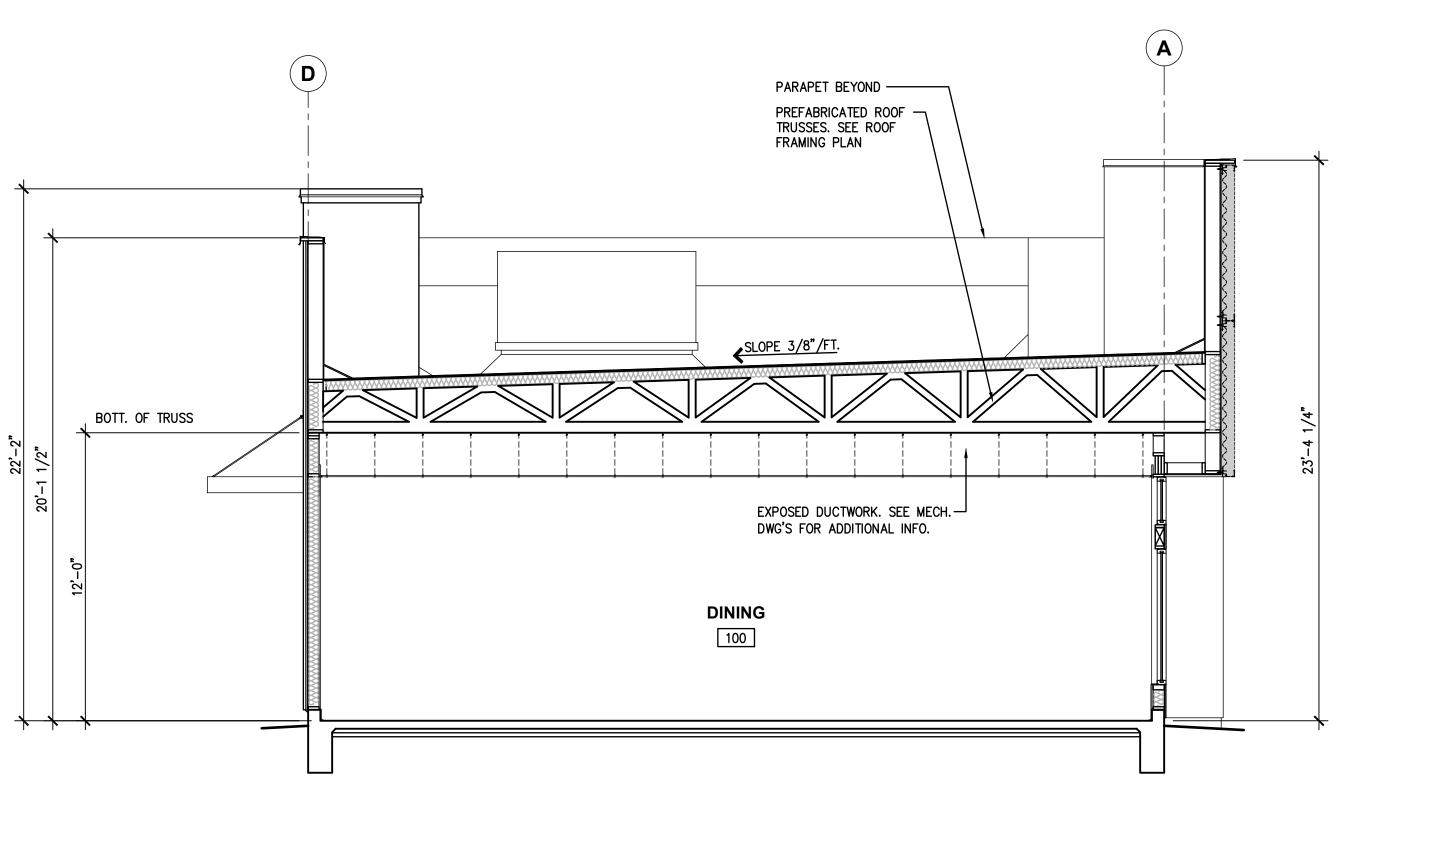

2 BUILDING CROSS SECTION

(1) BUILDING LONGITUDINAL SECTION

1/4" = 1'-0"

3 BUILDING CROSS SECTION





9330 BALBOA AVENUE
SAN DIEGO, CA 92123
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DATES

without its previous written consent

 RELEASE:
 OCT.
 02,
 2017

 P.M.
 UPDATES:
 SEPT.
 27,
 2019

SUBMITTAL DATE:
1:_____

BID: ____

CONSTRUCTION: ____

REVISIONS

\[\lambda \]
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\[\lambda \]
\[\lambda \]

O. C-28504
REN. 1/31/23



ROCKLIN, CA 95677 (916) 415-5358 rpedro@pmdginc.com

SUITE 100

SITE INFORMATION

Roy W. Pedro, Architect

MK TYPE: MK9DS_MD

JIB #: <u>4387</u> ADDRESS:

1240 W. WOOD ST. WILLOWS, CA 95988

DRAWN BY:

CH (COMMERCIAL HIGHWAY)

64 INDOOR SEATS NO OUTDOOR DINING SEATING

24 STANDARD SPACES
2 ADA ACCESSIBLE SPACES
2 COMPACT SPACES
1 FUTURE E.V. SPACES

30 TOTAL SPACES

1 LOADING SPACE PER SEC. 18.120.030

1 SPACE PER 200 SQ. FT. = 2739/200 = 13.7 SPACES

A-2 - RESTAURANT

2,739 SQ.FT.

ZONING:

OCCUPANCY:

BUILDING AREA:

PARKING REQUIRED:

PARKING PROVIDED:

SEATING:

PROJECT #: WFM20001.0

SCALE: 1" = 10'

PROPOSED SITE PLAN

SD1.0

REVISED LANDSCAPE PLAN

TREES QTY BOTANICAL / COMMON NAME

<u>SHRUBS</u>

PLANT SCHEDULE

Lagerstroemia indica `Red Rocket` / Crape Myrtle15 gal Low

3 Ulmus x `Frontier` / American Elm

15 gal Moderate

15 gal Moderate

5 gal. Low

5 gal Low

CONT WUCOLS

Zelkova serrata `Village Green` / Sawleaf Zelkova

QTY BOTANICAL / COMMON NAME

CONT WUCOLS

138 Callistemon viminalis `Little John` / Dwarf Weeping Bottlebrush 5 gal Low

95 Dietes x `Lemon Drop` / Fortnight Lily

98 Grevillea x `Noellii` / Grevillea 5 gal Low
68 Phormium x `Dark Delight` / Dark Delight Purple Flax 5 gal. Low

40 Rhaphiolepis umbellata `Eleanor Tabor` / Yedda Hawthorn

GROUND COVERS QTY BOTANICAL / COMMON NAME CONT WUCOLS

24 Myoporum parvifolium / Trailing Myoporum 1 gal Low 60" o.c.

192 Rosa x `Red Drift` / Drift Rose 1 gal. Low 30" o.c.




- 1. All landscape planting areas shall receive a minimum 3" layer of organic mulch top dressing.
- 2. All trees, shrubs and groundcover shall be irrigated with a drip system, smart controller, weather sensor, etc.and shall meet City of Willows Water Efficient standards/regulations.
- 3. All new trees located within 7' of pavement or permanent structure shall have a root barrier.

COMPLIANCE STATEMENT

I have complied with the criteria of the water use ordinance and applied them accordingly for the efficient use of water in the landscape design plan.



-4-21

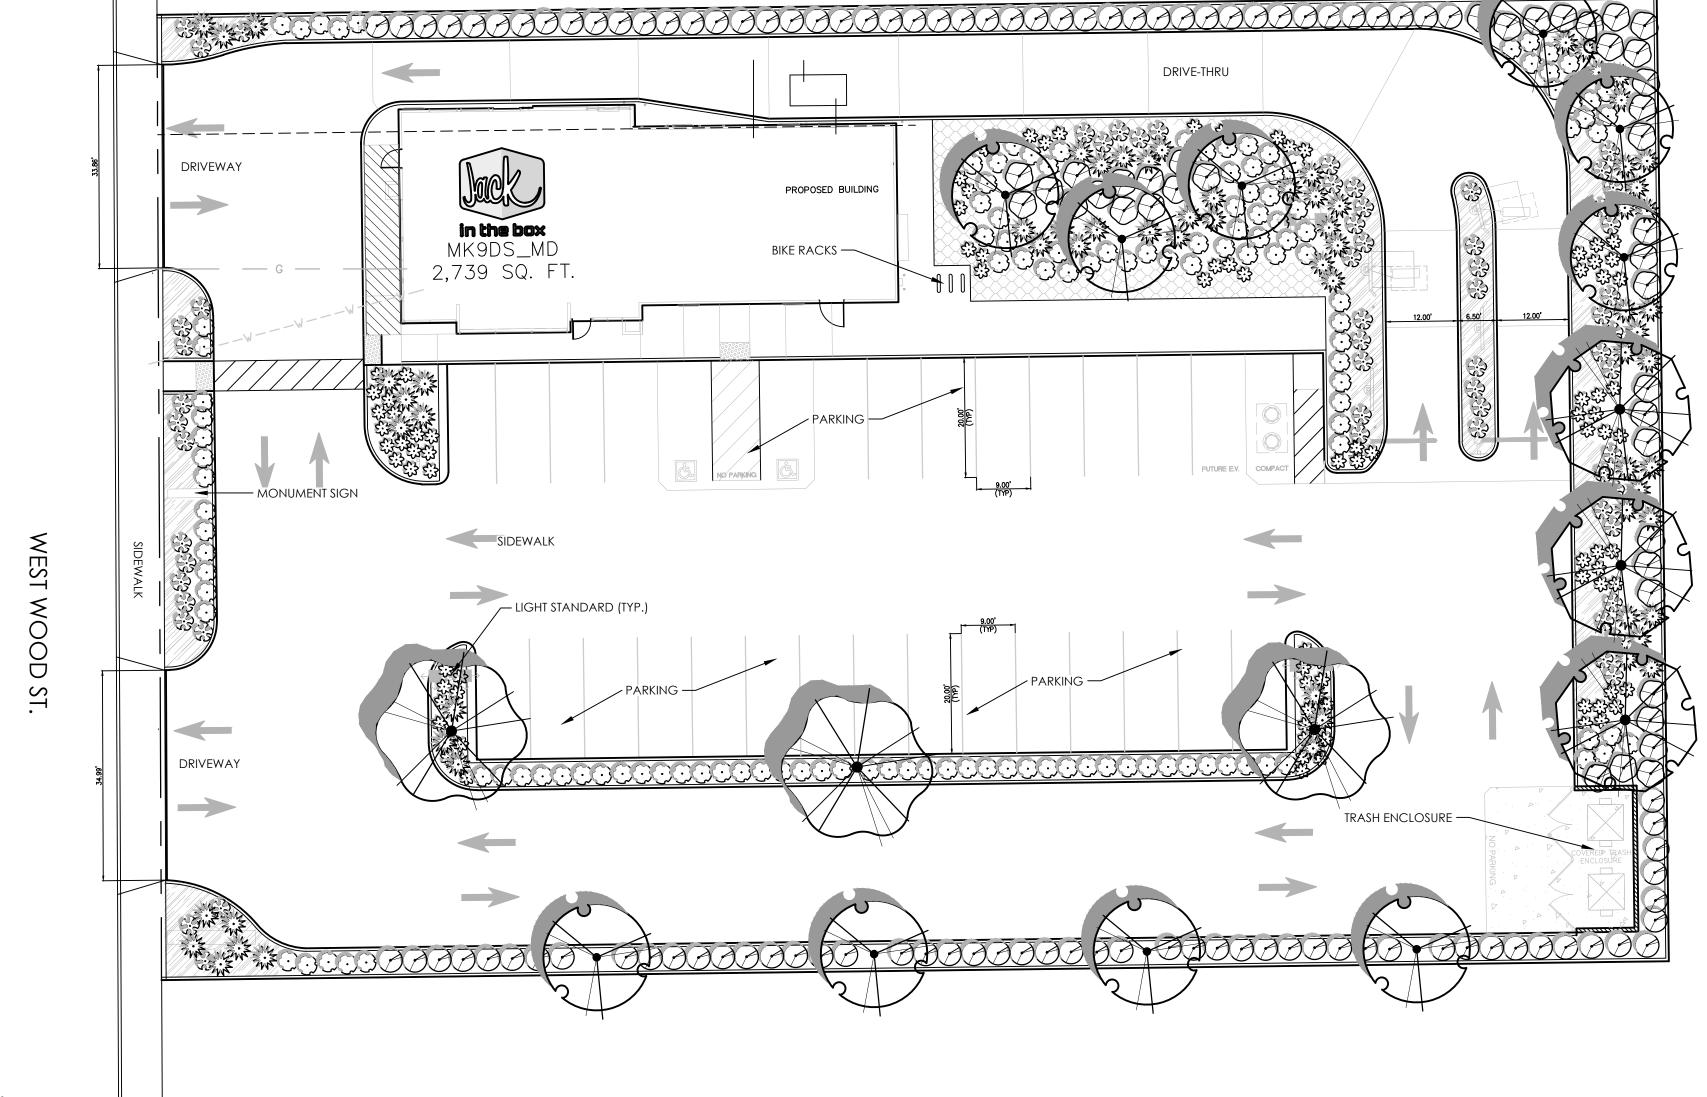

Water Efficient Landscape Worksheet

HYDROZONE/PLANTING DESCRIPTION	PLANT FACTOR (PF)	IRRIG. METHOD	IRRIG. EFFICIENCY (IE)	ETAF (PF/IE)	LANDSCAPE AREA (Sq. Ft.)	ETAF x AREA	ESTIMATED TOTA WATER USE (ETWU)
REGULAR LANDSCAPE AREA							
LOW WATER USE PLANTS	.3	DRIP	.81	.37	8,305	3,073	97,740 GAL.
MODERATE WATER USE PLANTS	.5	DRIP	.81	.62	125	78	2,481 GAL.
	•	•		TOTALS	(A) 8,430	(B)3,151	
						TM/II Total	100 221 CAL

Maximum Applied Water Allowance (MAWA). MAWA= (ETO) (Conversion factor) ((ETAF) (Landscape Area)) + ((1-ETAF) x SLA) (51.3) (.62) (.45 x 8,430) + (1-.45) X 0) = 120,656 GALLONS

Estimated Total Water use (ETWU). ETWU= (ETO)) (Conversion factor) ((ETAF) (Area)) (51.3) (.62) (3,151) = 100,221 GALLONS

ETAF Calculations

Regular Landscape Areas

Total ETAF x Area	(B) 3,151	
Total Area	(A) 8,430	
Average ETAF	(B / A) .37	

Note:
1. Average ETAF for Regular Landscape
Areas must be below .55 for residential
areas and .45 for non-residential areas.



9330 BALBOA AVENUE
SAN DIEGO, CA 92123

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DATES

 RELEASE:
 OCT. 02, 2017

 P.M. UPDATES:
 SEPT. 27, 2019

SUBMITTAL DATE: 1: 7/14/21

2:_____

CONSTRUCTION:

REVISIONS

OLIVE STREET LANDSCAPE ARCHITECTURE

P.O. Box 2083
Petaluma CA 94952
707-280-8990
OliveStreetLandscape.com
rod@olivestreetlandscape.com





(916) 415-5358 rpedro@pmdginc.com

Roy W. Pedro, Architect

SUITE 100 ROCKLIN, CA 95677

SITE INFORMATION

MK TYPE: MK9DS_MD

 MK TYPE:
 MK9DS_ME

 JIB #:
 4387

ADDRESS: 1240 W. WOOD ST.

WILLOWS, CA 95988


| DRAWN BY: ______
| PROJECT #: WFM20001.0

SCALE: $\frac{1" = 16'}{1}$

LANDSCAPE PLAN

L1

PLANT SCHEDULE

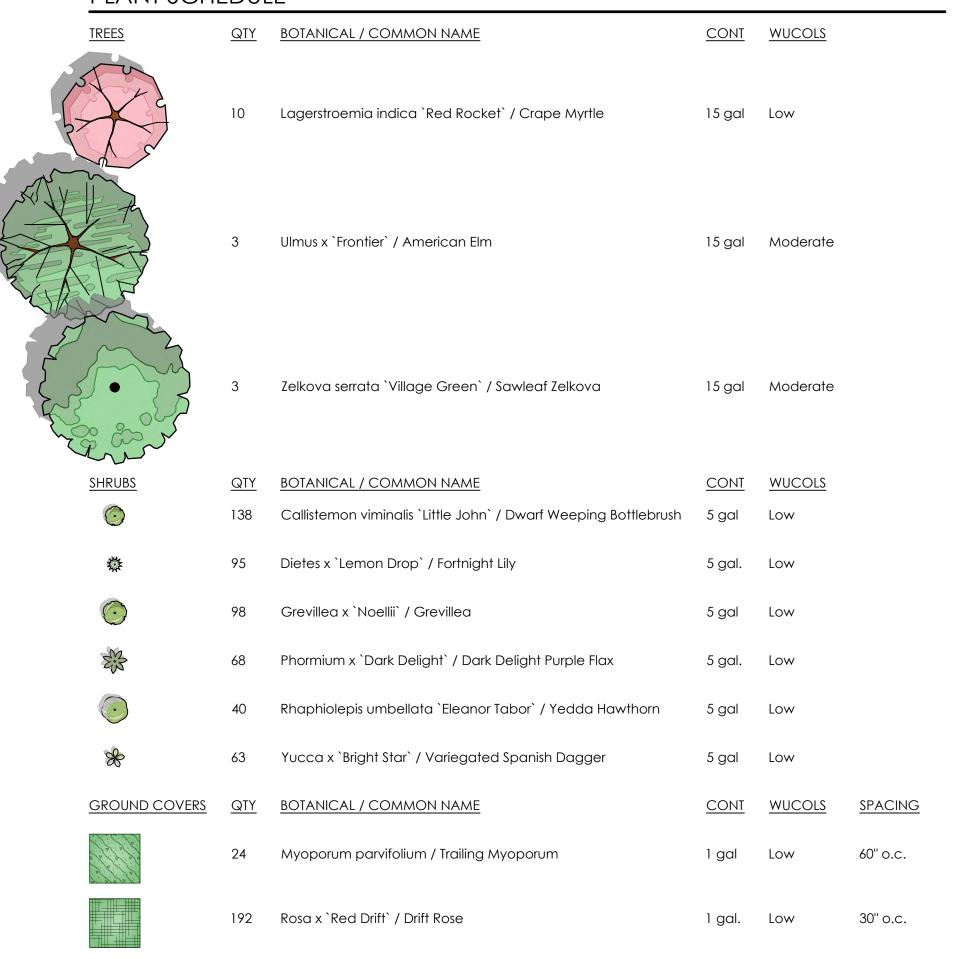

GENERAL NOTES


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3-4-21



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Areas must be below .55 for residential
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 27,
 2019

SUBMITTAL DATE: 1: 7/14/21
2:

3:_____

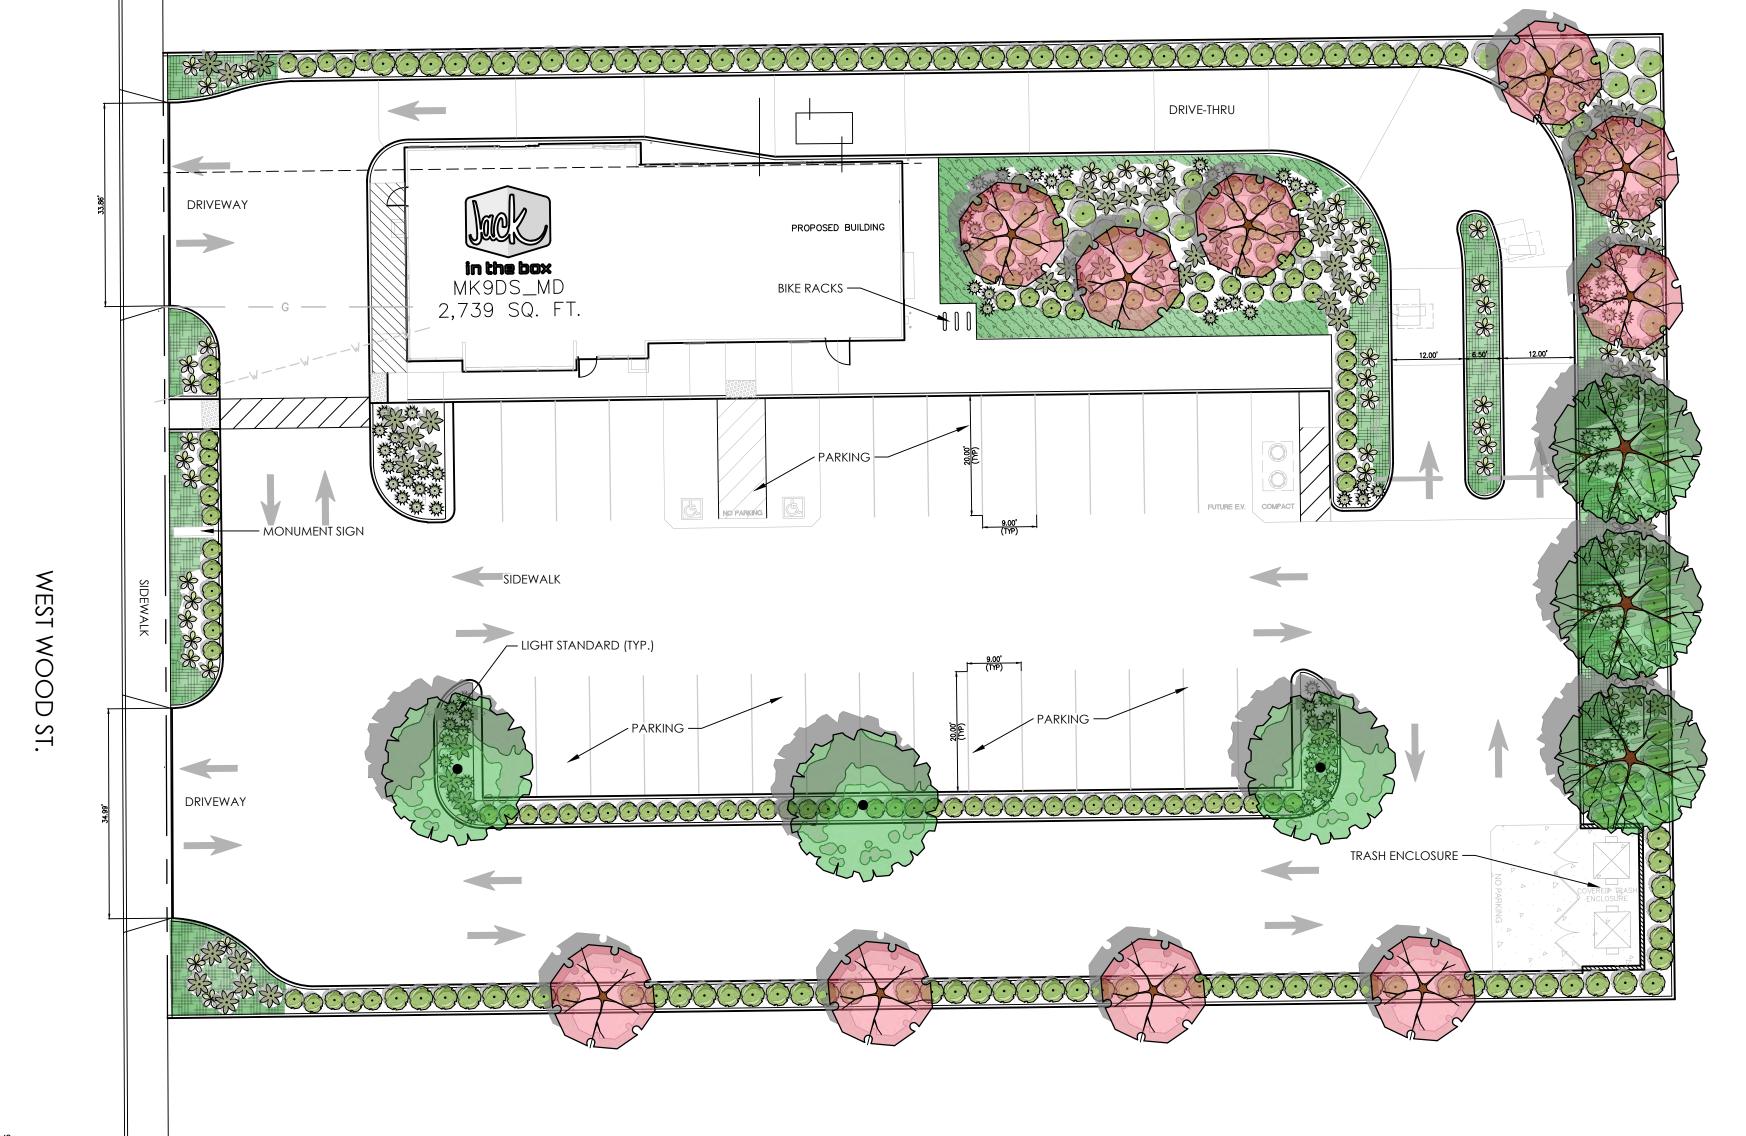CONSTRUCTION:

REVISIONS

\(\text{L} \)
\(\text{L} \)

OLIVE STREET
LANDSCAPE ARCHITECTURE

P.O. Box 2083
Petaluma CA 94952
707-280-8990
OliveStreetLandscape.com
rod@olivestreetlandscape.com





SUITE 100 ROCKLIN, CA 95677 (916) 415-5358 rpedro@pmdginc.com

6930 DESTINY DRIVE

Roy W. Pedro, Architect

SITE INFORMATION

 MK TYPE:
 MK9DS_MD

 JIB #:
 4387

ADDRESS: 1240 W. WOOD ST.


WILLOWS, CA 95988

DRAWN BY: ________PROJECT #: WFM20001.0

SCALE: 1" = 16'

LANDSCAPE PLAN

L1

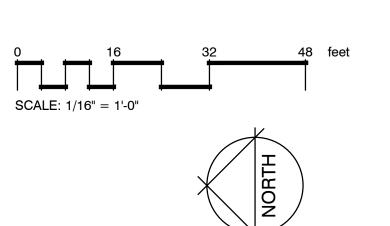



PERMIT# 4791 JOB COPY

Attachment

JACK IN THE BOX #4387 1240 W Wood St, Willows, CA 95988 USA

PERMIT

ORIGINAL DESIGN: 3/12/21-JMc

R1: Updated pylon to J200. 7/26/21-JMc

R2: Added single/double face square footage column in sign legend, added note that sign area of poster marquees is V.O. with changeable graphics. 10/18/22-JMc

R3: Added notes to site plan, added tables and letter heights to directional sign detail pages. 3/23/23-JMc

R4: Added Statement of Special Inspections note to site plan. 9/6/23-JMc

ALL PHASES OF CONSTRUCTION ARE SUBJECT TO FIELD APPROVAL.
APPROVED PLANS, CALCS, & JOB CARDS MUST BE ON SITE FOR ALL INSPECTIONS.
ALL PERMITS ARE REQUIRED TO PASS FINAL INSPECTION.

NOTICE ALL WORK SHALL COMPLY WITH THE LATEST EDITIONS OF THE CBC, CPC, CMC, & THE NEC AS ADOPTED & AMENDED BY THE STATE OF CALIFORNIA IN TITLE 24 CCR AND THIS JURISDICTION, & ANY OTHER REGULATION EFFECTING THIS PROJECT ADOPTED BY FEDERAL, STATE OR LOCAL GOVERNMENT.

TO AVOID DELAYS ANY CHANGES TO THE APPROVED PLAN MUST BE REVIEWED AND APPROVED BY THE BUILDING DEPARTMENT



REVIEWED FOR CODE COMPLIANCE BY COASTLAND CIVIL ENGINEERING INC.

BY COASTLAND CIVIL ENGINEERING, INC. IN ACCORDANCE WITH CBC §107.3.1 AS AMENDED BY THE LOCAL AGENCY.



Digitally signed by Betty Li

Date: 2024.05.01 06:48:09 -07'00'


Checking is only for general conformance with the design concept of the project and general compliance with the information given in the contract
documents. Checking neither determines accuracy of quantities or dimensions or substantiates installation instructions or performance of equipment or systems designed by contractor. Contractor is responsible for complying with the contract documents, including dimensions, quantities, coordination among trades, designs by constructions means, methods, techniques, sequences, procedures, and safety programs.



Reviewed By gborchardt

Date Apr 16 2024



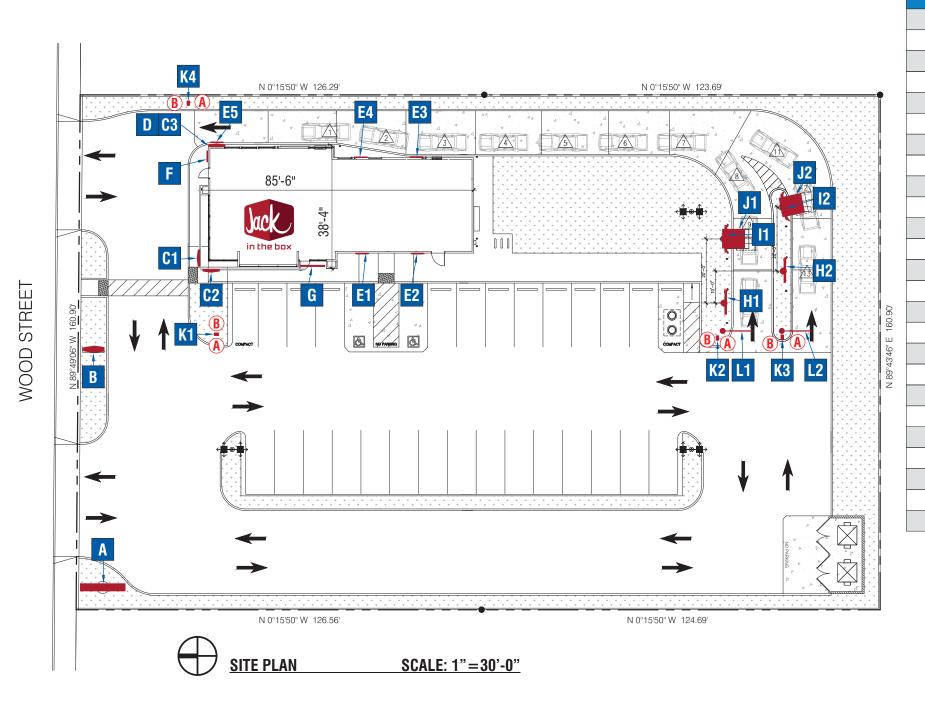

Statement of Special Inspections:

Where special inspections or tests are required by Section 1705, the registered design professional in responsible charge shall prepare a statement of special inspections in accordance with Section 1704.3.1 for submittal by the applicant in accordance with Section 1704.2.3.

4444 Federal Blvd San Diego, CA 92102

(619) 527-6100 signtech.com

Exception: The statement of special inspections is permitted to be prepared by a qualified person approved by the building official for construction not designed by a registered design professional.



JACK IN THE BOX

J4387 1240 W Wood St, Willows, CA 95988 USA Sales: Bob McCarter
Coordinator: Thea Tochihara
Design: JMc

date: 3/12/21 drawing: J4387-PERMIT revision: R4-9/6/23-JMc project ID: JIB_4387_2

J30 MONUMENT SIGN JITB-MON-J30-96x69 26.6 ea. N/A 1 C1 J30 WALL SIGN JITB-J30 N/A 27.76 J30 WALL SIGN JITB-J30 27.76 N/A J30 WALL SIGN JITB-J30 N/A 27.76 J30 WALL SIGN HALO KIT JITB-J30-HALO KIT N/A N/A POSTER MARQUEE - SINGLE N/A JITB-WC-60x49-MARQUEE 11.83 POSTER MARQUEE - SINGLE JITB-WC-60x49-MARQUEE N/A 11.83 POSTER MARQUEE - SINGLE JITB-WC-60x49-MARQUEE N/A 11.83 POSTER MARQUEE - SINGLE E4 JITB-WC-60x49-MARQUEE N/A 11.83 POSTER MARQUEE - SINGLE JITB-WC-57x79-MARQUEE N/A 11.83 F ILLUM. ADDRESS CABINET JITB-WC-16x42-ADDRESS-1230 N/A 4.7 1 JITB-FCO-AL-8 NEIGHBORHOOD LETTERS N/A N/A PREVIEW MENU - BY OTHERS PREVIEW MENU BY NATIONAL SIGNS 1 H1 N/A 26 H2 PREVIEW MENU - BY OTHERS PREVIEW MENU BY NATIONAL SIGNS N/A 26 1 11 SPEAKER MENU - BY OTHERS SPEAKER MENU BY NATIONAL SIGNS N/A 27.1 1 SPEAKER MENU - BY OTHERS SPEAKER MENU BY NATIONAL SIGNS N/A 27.1 J1 SPEAKER MENU CANOPY JITB-CAN-72x84-120 N/A 1 N/A J2 SPEAKER MENU CANOPY JITB-CAN-72x84-120 N/A N/A K1 DIR. SIGN - "DRIVE-THRU" JITB-DIR-17x17x48-DRIVETHRU-LEFT/RIGHT 2.3 N/A 1 2.3 DIR. SIGN - "DRIVE-THRU" JITB-DIR-17x17x48-DRIVETHRU-LEFT/RIGHT N/A K3 DIR. SIGN - "DRIVE-THRU" JITB-DIR-17x17x48-DRIVETHRU-LEFT/RIGHT N/A 2.3 1 DIR. SIGN - "TY/DNE" JITB-DIR-17x17x48-THANKYOU/DONOTENTER N/A 2.3 HEIGHT DETECTOR JITB-H-BAR-120 1 L1 N/A N/A HEIGHT DETECTOR JITB-H-BAR-120 N/A N/A

SIGN LEGEND

JITB-PYL-J200-183x168x960

SIGN TYPE

DESCRIPTION

J200 PYLON @ 80'-0"

SIGN #

DRAWINGS CONFORM WITH CALIFORNIA
BUILDING CODE 2022 AND ELECTRICAL CODE 2022

AN ELECTRICAL DISCONNECT FOR ALL ELECTRICALLY POWERED SIGNAGE SHALL BE PROVIDED WITHIN LINE OF SIGHT FROM THE SPECIFIC SIGNAGE BEING POWERED.

ALL POST-MOUNTED SIGNS SHALL BE ELECTRICALLY BONDED
AND GROUNDED TO THE POST ANCHOR BOLTS AND PIER REINFORCEMENT

S/F


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N/A

Sq. Ft.


196.48 ea.

QTY

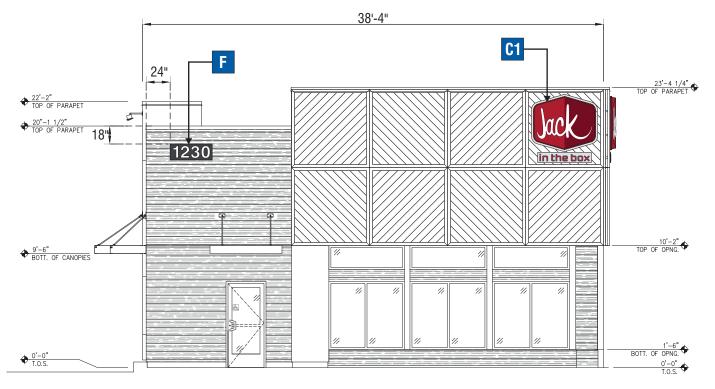

NORTH / FRONT ELEVATION

SCALE: 1/8"=1'-0"

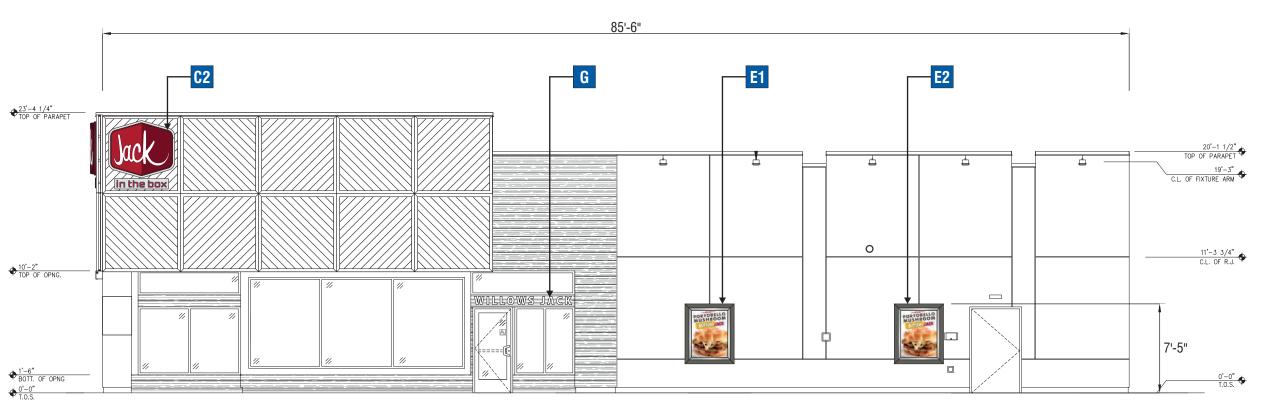



WEST / RIGHT ELEVATION

4444 Federal Blvd San Diego, CA 92102 (619) 527-6100 signtech.com

SCALE: 1/8"=1'-0"



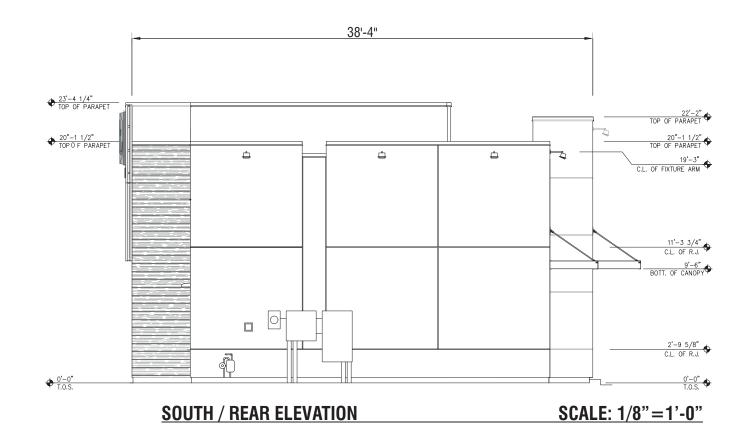

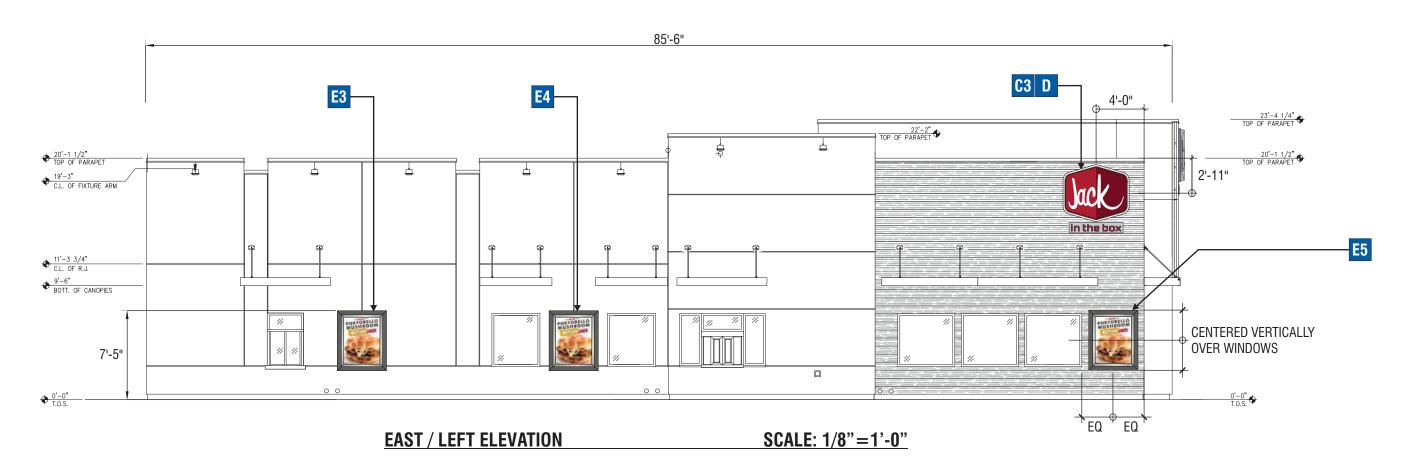






JACK IN THE BOX

J4387 1240 W Wood St, Willows, CA 95988 USA Sales: Bob McCarter Coordinator: Thea Tochihara Design: JMc

Engineering:

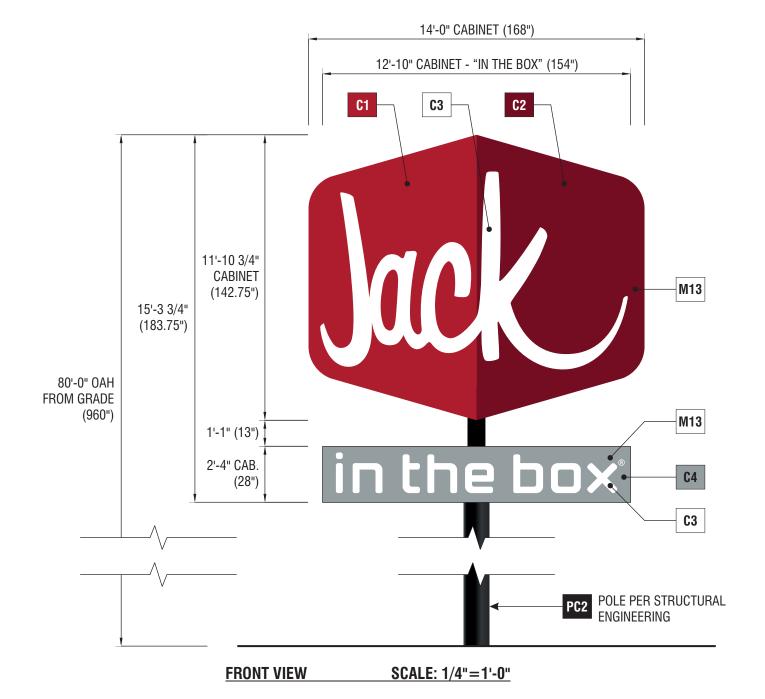

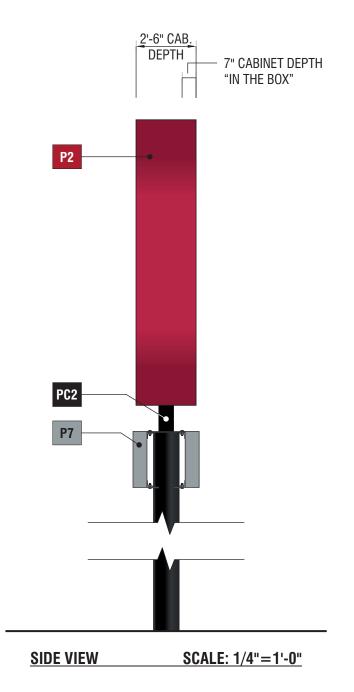

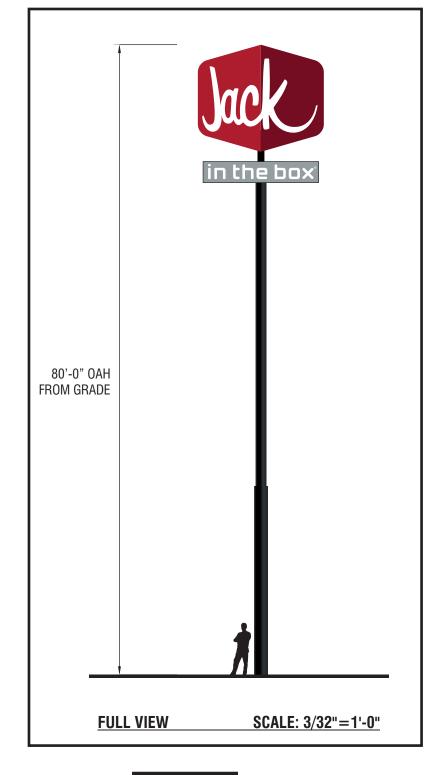

SIGNTYPE JITB-PYL-J200-183x168x960

MANUFACTURE AND INSTALL ONE (1) D/F INTERNALLY ILLUMINATED J200 PYLON SIGN

4444 Federal Blvd San Diego, CA 92102

(619) 527-6100 signtech.com

UPPER CABINET: FABRICATED ALUMINUM WITH INTERNAL LED ILLUMINATION LOWER CABINET: FABRICATED ALUMINUM WITH INTERNAL LED ILLUMINATION

FACES: PANAFLEX WITH DIGITALLY PRINTED GRAPHICS **POLE**: STEEL POLE PER STRUCTURAL ENGINEERING

ILLUMINATION: LED

COLORS

- DIGITALLY PRINTED COLORS TO MATCH PMS 187C
- C2 DIGITALLY PRINTED COLORS TO MATCH PMS 188C
- C3 DIGITALLY PRINTED COLORS TO MATCH PMS PROCESS WHITE
- DIGITALLY PRINTED COLORS
 TO MATCH PMS 60% PMS 431C

PAINT

- TO MATCH MP 64691 'JIB RED' OPAQUE PAINT
- P7 TO MATCH MP 02065 'SLATE GRAY
- PC2 POWDER COATED TO MATCH RAL 9004 'SIGNAL BLACK' W/ SATIN FINISH

MATERIAL

- M10 .150" WHITE MODIFIED ACRYLIC WITH FIRST SURFACE DIGITAL PRINT (PRINT GRAPHIC VARIES)
- M13 DIGITALLY PRINTED PANAFLEX FACE




JACK IN THE BOX

J4387 1240 W Wood St, Willows, CA 95988 USA

Sales: Bob McCarter **Coordinator:** Thea Tochihara

Design: JMc Engineering:

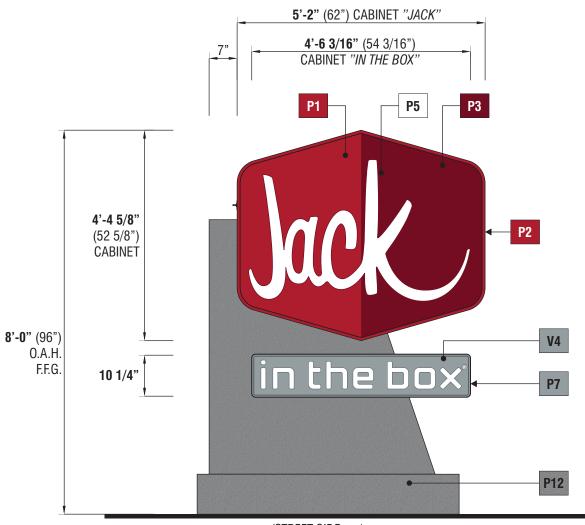

in the box

 $(STREET\ SIDE \longrightarrow)$

SIDE A SCALE: 1/2"=1'-0"

UPPER CABINET: 22.7 SQ. FT. LOWER CABINET: 3.9 SQ. FT. **TOTAL**: 26.6 SQ. FT.

B SIGNTYPE JITB-MON-J30-96x69

MANUFACTURE AND INSTALL ONE (1) D/F INTERNALLY ILLUMINATED J30 MONUMENT SIGN

UPPER CABINET: FABRICATED ALUMINUM WITH INTERNAL LED ILLUMINATION LOWER CABINET: FABRICATED ALUMINUM WITH INTERNAL LED ILLUMINATION

FACES: FORMED LEXAN WITH SECOND SURFACE GRAPHICS

BASE: FABRICATED ALUMINUM

ILLUMINATION: LED - SLOAN PRISM 5700K WHITE

TO MATCH LACRYL SERIES 400 LW-5-9404-1 TRANSLUCENT PAINT

SCALE: 1/2"=1'-0"

TO MATCH MP 64691 'JIB RED' OPAQUE PAINT

TO MATCH LACRYL SERIES 400 443 'DEEP RED' TRANSLUCENT PAINT

P5 TO MATCH LACRYL SERIES 400 L-403-W TRANSLUCENT PAINT

P7 TO MATCH MP 02065 'SLATE GRAY

TO MATCH SHERWIN WILLIAMS SW7018 'DOVETAIL' W/ SATIN FINISH AND MEDIUM TEXCOTE VINYL

3M 3630-61 'SLATE GRAY'

SIDE B

JACK IN THE BOX

J438/ 1240 W Wood St, Willows, CA 95988 USA

Sales: Bob McCarter Coordinator: Thea Tochihara

Design: JMc Engineering:

date: 3/12/21 drawing: J4387-PERMIT revision: R4-9/6/23-JMc project ID: JIB_4387_2


END VIEW SCALE: 1/2"=1'-0"

1'-3"

CABINET

1'- 0 1/2"



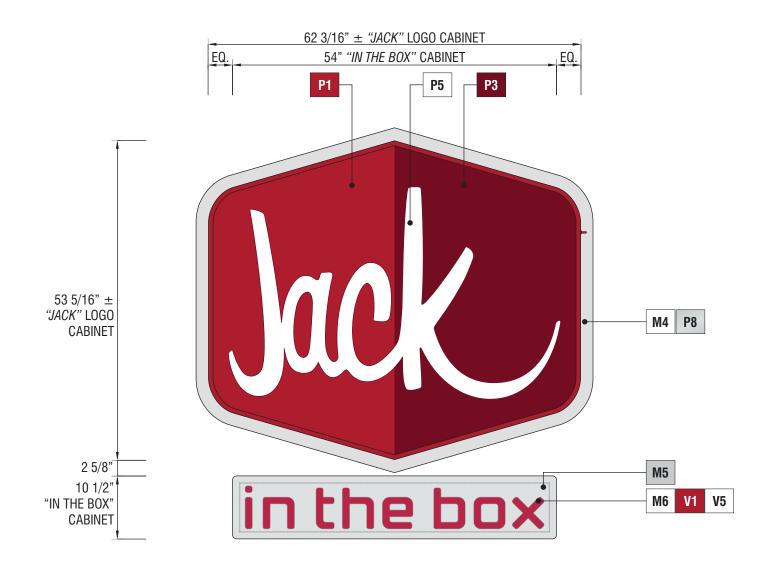

FRONT VIEW SCALE: 3/4"=1'-0" 27.76 SQ. FT.

C1 C2 C3 SIGNTYPE JITB-J30

MANUFACTURE AND INSTALL THREE (3) S/F INTERNALLY ILLUMINATED J30 WALL SIGN(S)

UPPER CABINET: FABRICATED ALUMINUM WITH INTERNAL LED ILLUMINATION AND UL APPROVED

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DISCONNECT SWITCH

LOWER CABINET: FABRICATED ALUMINUM WITH INTERNAL LED ILLUMINATION **UPPER FACE:** FORMED POLYCARBONATE WITH SECOND SURFACE GRAPHICS

LOWER FACE: ROUTED ACM WITH PUSH-THRU ACRYLIC COPY

LOGO BORDER: ACM **ILLUMINATION: LED**

MATERIALS

3 1/2" CHANNEL LETTER COIL PRE-COATED MP 64691 "JIB RED" WITH SATIN FINISH

M4 3MM WHITE ACM (0.118" SKIN)

M5 3MM SILVER ACM (0.118" SKIN)

M6 3/4" CLEAR ACRYLIC



3" CABINET

END VIEW SCALE: 3/4"=1'-0"

TO MATCH LACRYL SERIES 400 LW-5-9404-1 TRANSLUCENT PAINT

TO MATCH LACRYL SERIES 400 443 'DEEP RED' *TRANSLUCENT PAINT*

TO MATCH LACRYL SERIES 400 L-403-W *TRANSLUCENT PAINT*

TO MATCH MP 30136 'BRUSHED ALUMINUM'


VINYL

3M 3630-73 'DARK RED'

V5 3M 3635-70 '60% DIFFUSER'



Design: JMc **Engineering:**

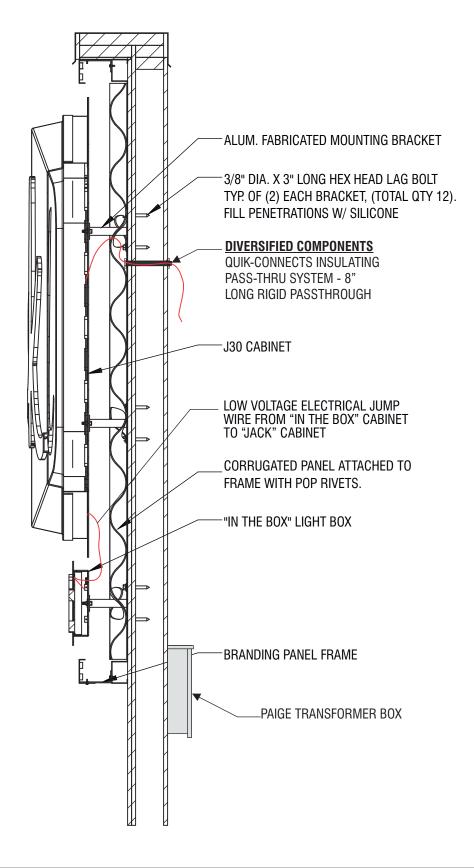



INSTALLATION VERTICAL SECTION

Scale: 1" = 1'-0"

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C3


VERTICAL SECTION

1240 W Wood St, Willows, CA 95988 USA

Sales: Bob McCarter **Coordinator:** Thea Tochihara Design: JMc

date: 3/12/21 drawing: J4387-PERMIT revision: R4-9/6/23-JMc project ID: JIB_4387_2


Scale: 1" = 1'-0"

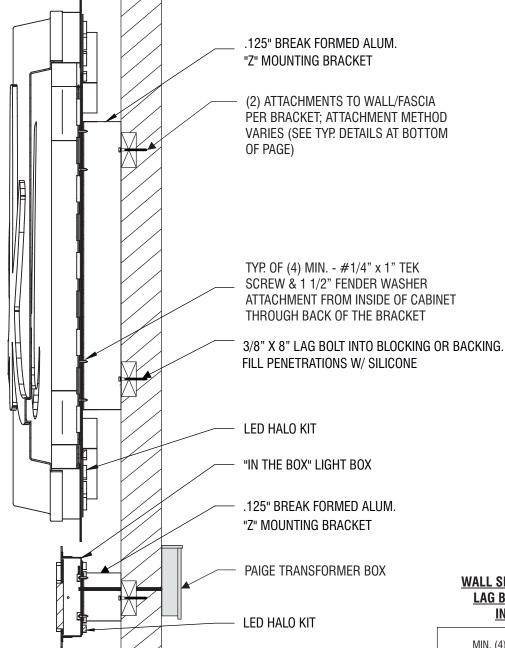

WALL SIGN SECTION DETAIL LAG BOLT ATTACHMENT **INTO BLOCKING**

MIN. (4) PER CABINET/ 2 1/2" EMBEDMENT (ATTACHMENT TYPE VARIES PER SURFACE):

\$10000:	3/8" SSTL. BULL W/
	NYLON ANCHOR
WOOD:	3/8" WOOD SCREW
	3/8" EXPANSION ANCHOR
DRYWALL:	3/8" TOGGLE BOLT

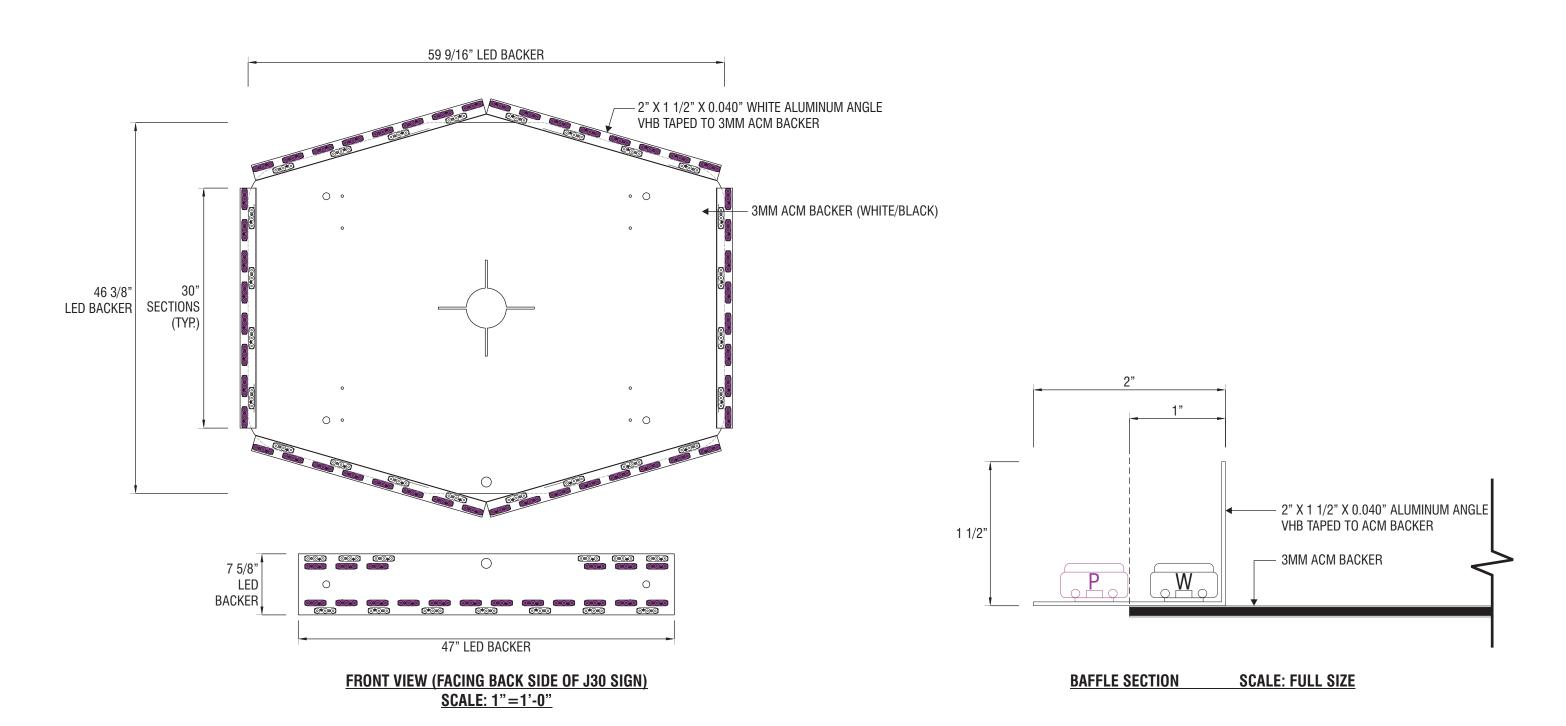



MANUFACTURE AND INSTALL ONE (1) J30 LED HALO KIT

BACKER: 3MM ACM (WHITE/BLACK)

BAFFLE: 2" X 1 1/2" X 0.040" PRE-COATED WHITE ALUMINUM ANGLE


4444 Federal Blvd San Diego, CA 92102 (619) 527-6100 signtech.com

ILLUMINATION: WHITE AND PURPLE LED



Coordinator: Thea Tochihara
Design: JMc
Engineering:

Sales: Bob McCarter

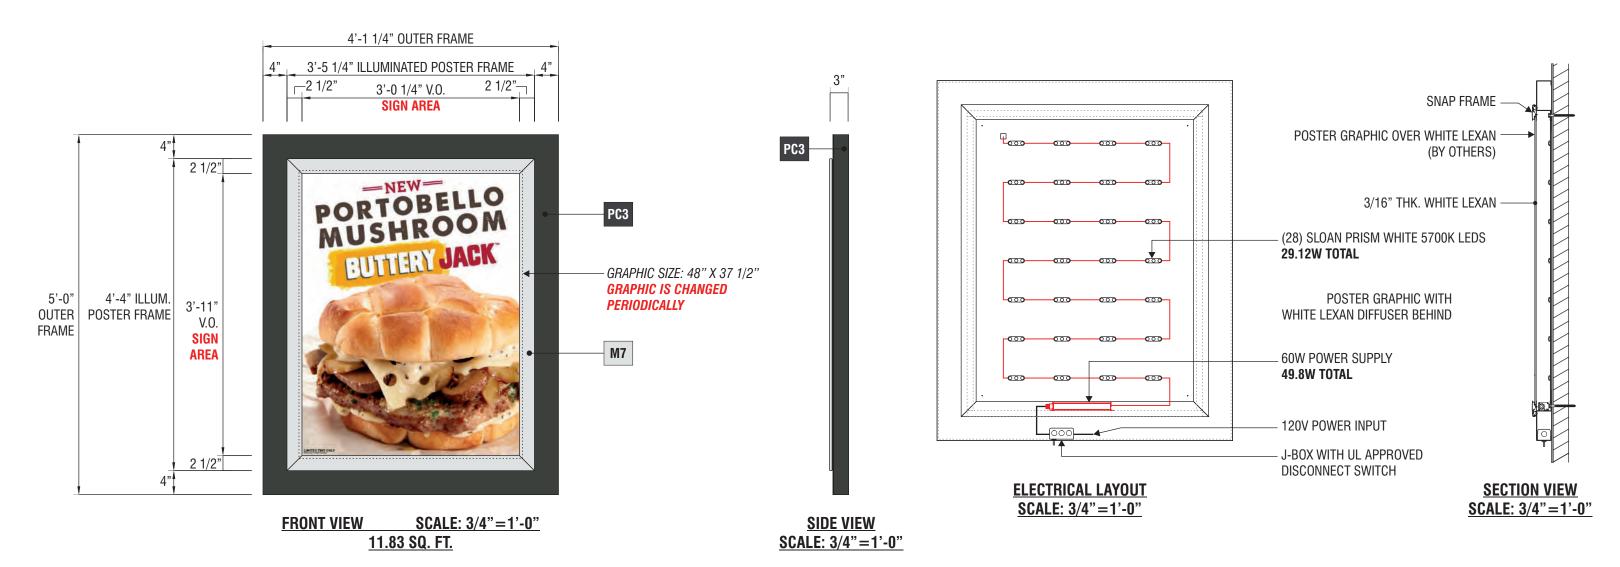

E1 E2 E3 E4 E5 SIGNTYPE JITB-WC-60x49-MARQUEE

MANUFACTURE AND INSTALL FIVE (5) ILLUMINATED SINGLE POSTER MARQUEE PANEL(S)

FACE: ROUTED 3/16" WHITE LEXAN WITH ATTACHED SNAP FRAME. INSERTS BY OTHERS

OUTER FRAME: FABRICATED .063" THICK ALUMINUM


ILLUMINATION: INTERNAL LED ILLUMINATION AND UL APPROVED DISCONNECT SWITCH

POWDER COAT

TO MATCH RAL7022 W/ SATIN FINISH 'UMBRA GREY'

MATERIALS

M7 ALUMINUM SNAP FRAME W/ CLEAR ANODIZED SATIN FINISH

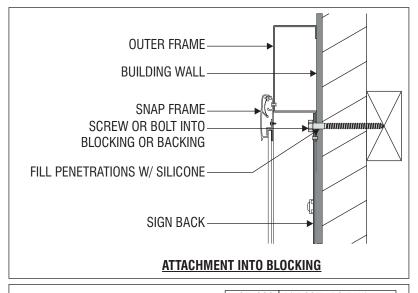

MIN. (4) PER CABINET/ 2	1/2"
EMBEDMENT (ATTACHME	
TYPE VARIES PER SURFA	

STUCCO:	3/8" SSTL. BOLT W/
	NYLON ANCHOR
	3/8" WOOD SCREW
CONCRETE:	3/8" EXPANSION ANCHOR
DRYWALL:	3/8" TOGGLE BOLT




JACK IN THE BOX

1240 W Wood St. Willows, CA 95988 USA

Sales: Bob McCarter **Coordinator:** Thea Tochihara

Design: JMc **Engineering:**

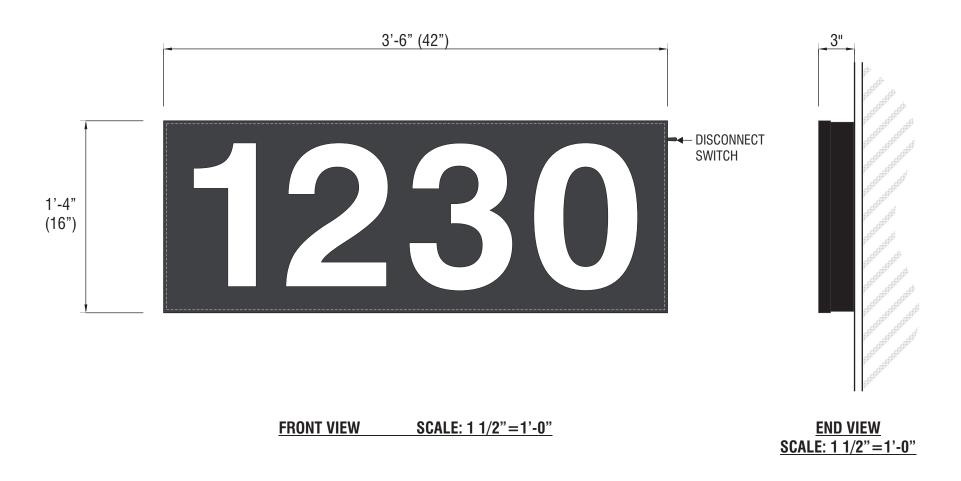

F SIGNTYPE JITB-WC-16x42-ADDRESS-1230

MANUFACTURE AND INSTALL ONE (1) PLEX FACE INTERNALLY ILLUMINATED ADDRESS CHANNEL LETTER

FACE: .177" THICK #7328 WHITE ACRYLIC WITH 3M NIMBUS GREY 101 (GERBER 220-41) ON FIRST SURFACE.


TRIMCAP: 1" BLACK JEWELITE

RETURNS: .040" x 3" DEEP PRE-PAINTED SATIN BLACK ALUM. COIL.

BACKS: .050" PRE-PAINTED WHITE ALUM.

ILLUMINATION: PRINCIPAL QWIK MOD 3 6500K WHITE

STUCCO: 1/4" SSTL. BOLT W/ NYLON ANCHOR WOOD: 1/4" LAG WOOD SCREW CONCRETE: 1/4" EXPANSION ANCHOR DRYWALL: 1/4" TOGGLER BOLT

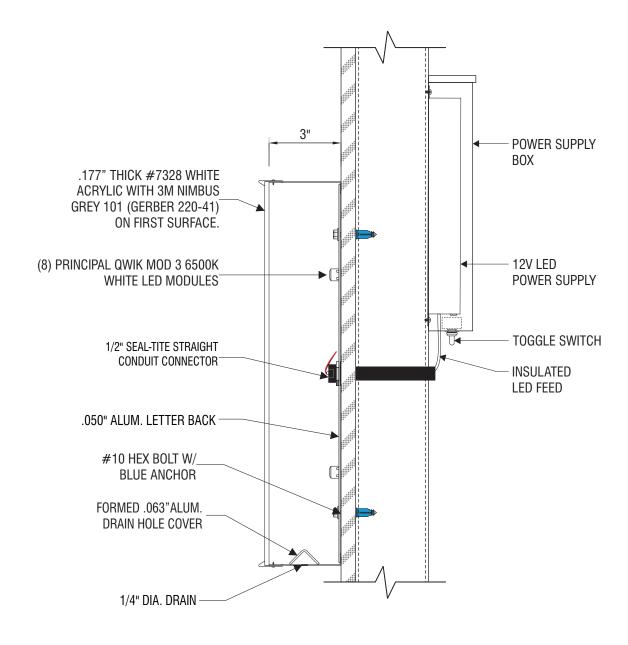

SCALE: 3"=1'-0" **SECTION VIEW**



JACK IN THE BOX


1240 W Wood St. Willows, CA 95988 USA

Sales: Bob McCarter **Coordinator:** Thea Tochihara

Design: JMc **Engineering:**

date: 3/12/21 drawing: J4387-PERMIT revision: R4-9/6/23-JMc project ID: JIB_4387_2

REMOVE NOTES AFTER ADJUSTMENT

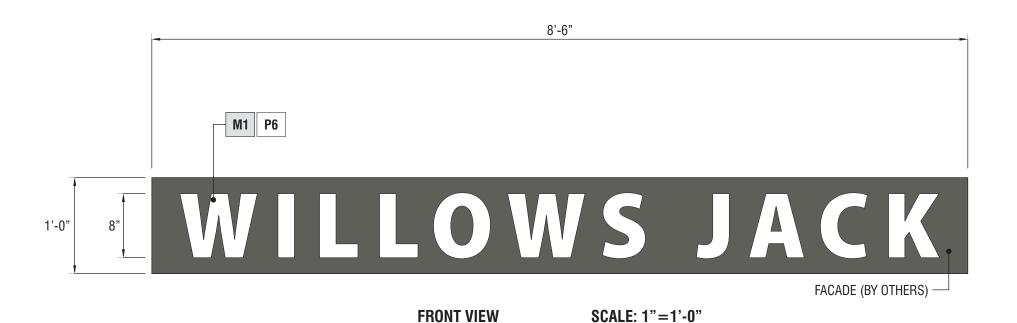

SCALE: 1"=1'-0"

10-24 X 1 1/2" ALUMINUM STUD POP WELDED TO BACK OF LETTER 1/8" ALUMINUM LETTER SILICONE 1/2" ANODIZED SILVER STANDOFFS

> **SECTION VIEW SCALE: HALF SIZE**

SIGNTYPE JITB-FCO-AL-8


MANUFACTURE AND INSTALL ONE (1) SET OF NON-ILLUMINATED WALL MOUNTED FCO NEIGHBORHOOD SIGN LETTERS

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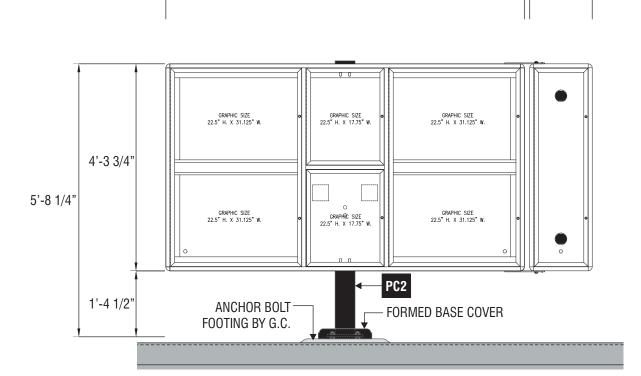
PAINT P6 POWDER COAT WHITE - SATIN FINISH **MATERIALS M1** 1/8" ALUMINUM







PLAN VIEW SCALE: 1/2"=1'-0"

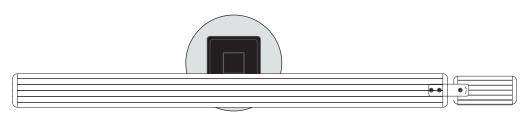7'-5 5/8"



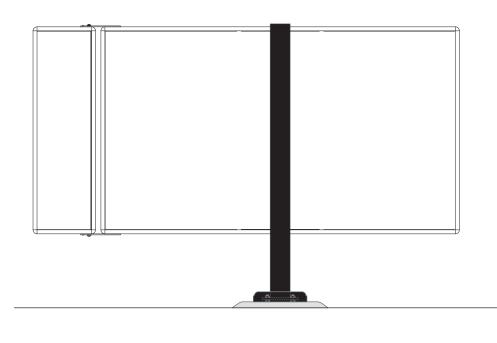

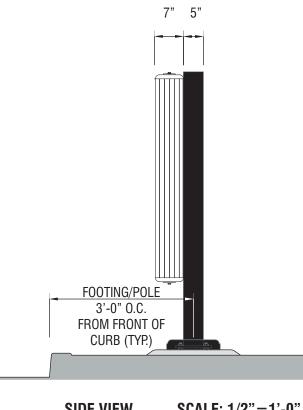

FRONT VIEW SCALE: 1/2"=1'-0"

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REAR VIEW SCALE: 1/2"=1'-0"

SCALE: 1/2"=1'-0" **SIDE VIEW**


H1 H2 SIGNTYPE PREVIEW MENU BY OTHERS


INSTALL ONE (1) PREVIEW MENU BY OTHERS WITH BREAKFAST EXTENDER

CABINET: MANUFACTURED BY NATIONAL SIGNS

POLE: 5" STEEL SQUARE TUBE



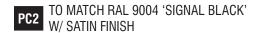


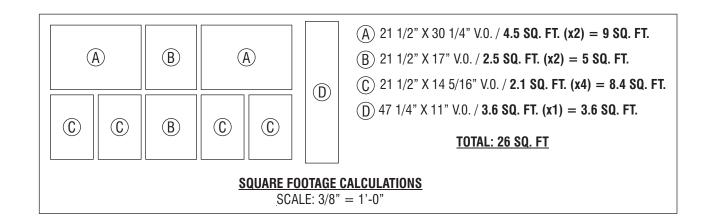




Engineering:

date: 3/12/21 drawing: J4387-PERMIT revision: R4-9/6/23-JMc project ID: JIB_4387_2

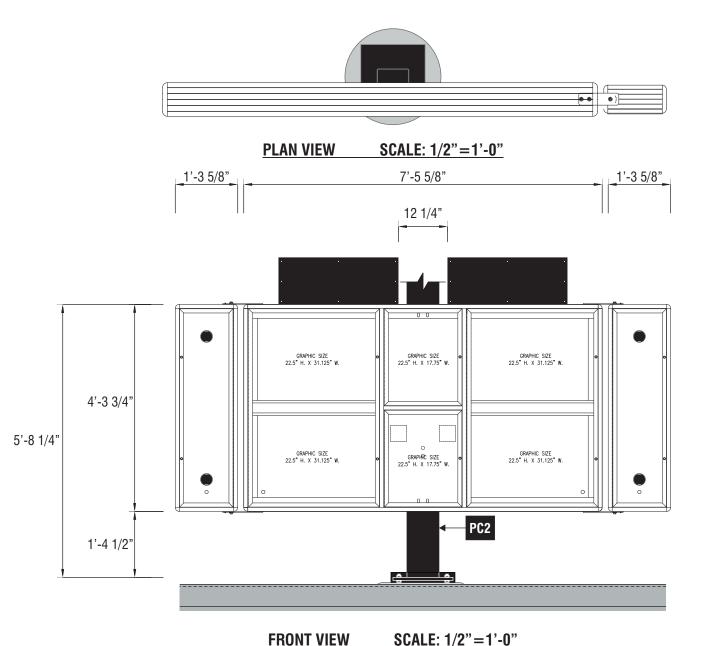

NOTE: MENU LUG-ON HARDWARE MUST BE SPACED CORRECTLY FOR GRAPHICS TO FIT.

REAR VIEW

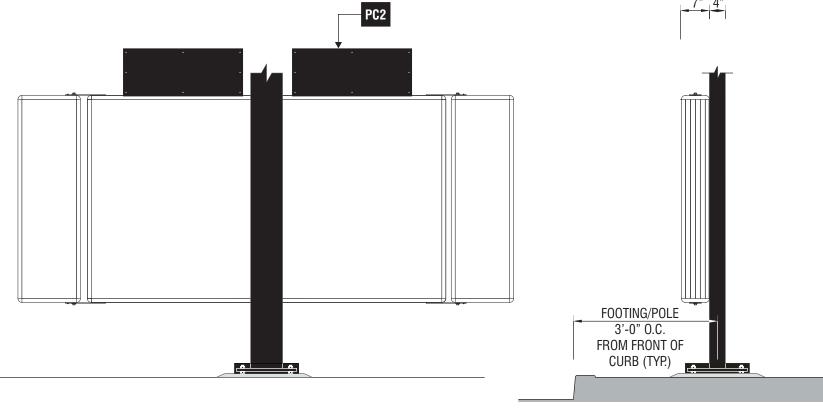

SIDE VIEW SCALE: 1/2"=1'-0"

I1 I2 SIGNTYPE SPEAKER MENU BY OTHERS


INSTALL ONE (1) SPEAKER MENU BY OTHERS WITH BREAKFAST & LATE NIGHT EXTENDERS BY OTHERS AND MENU LUG-ON HARDWARE **PANELS BY OTHERS**

CABINET: MANUFACTURED BY NATIONAL SIGNS

POLE: 4"x8" STEEL RECTANGULAR TUBE (SEE MENU CANOPY)



PC2 TO MATOLITICS W/ SATIN FINISH TO MATCH RAL 9004 'SIGNAL BLACK'

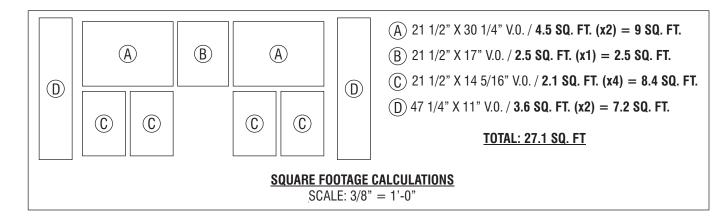



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JACK IN THE BOX

1240 W Wood St. Willows, CA 95988 USA


Sales: Bob McCarter **Coordinator:** Thea Tochihara

Design: JMc **Engineering:**


SCALE: 1/2"=1'-0"

date: 3/12/21 drawing: J4387-PERMIT revision: R4-9/6/23-JMc

project ID: JIB_4387_2

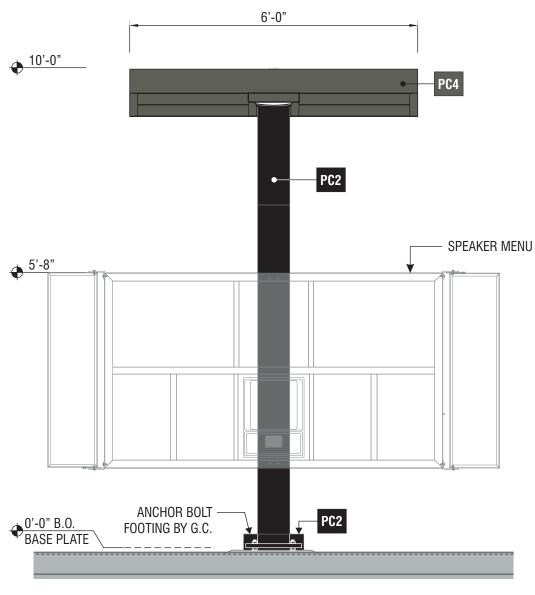

FRONT VIEW SCALE: 1/2"=1'-0"

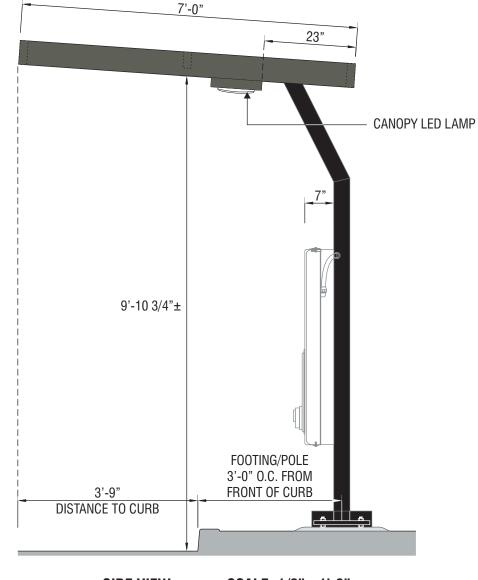

SCALE: 1/2"=1'-0" **SIDE VIEW**

J1 J2 SIGNTYPE JITB-CAN-72x84-120

MANUFACTURE AND INSTALL ONE (1) MENU WEATHER CANOPY

CANOPY: ALUMINUM RECT. TUBE FRAME WITH ALUMINUM ROOF AND ALUMINUM LAMP ENCLOSURE

POLE: 4"x8" STEEL RECTANGULAR TUBE W/ FABRICATED ALUMINUM BASE COVER ILLUMINATION: LED LAMP; COLOR TEMP: 5000K; WATTAGE: 42; LUMEN OUTPUT: 5003


POWDER COAT

PC2 TO MATCH RAL 9004 'SIGNAL BLACK' W/ SATIN FINISH

PC4 TO MATCH RAL7039 W/ SATIN FINISH 'QUARTZ GREY'



Sales: Bob McCarter **Engineering:**

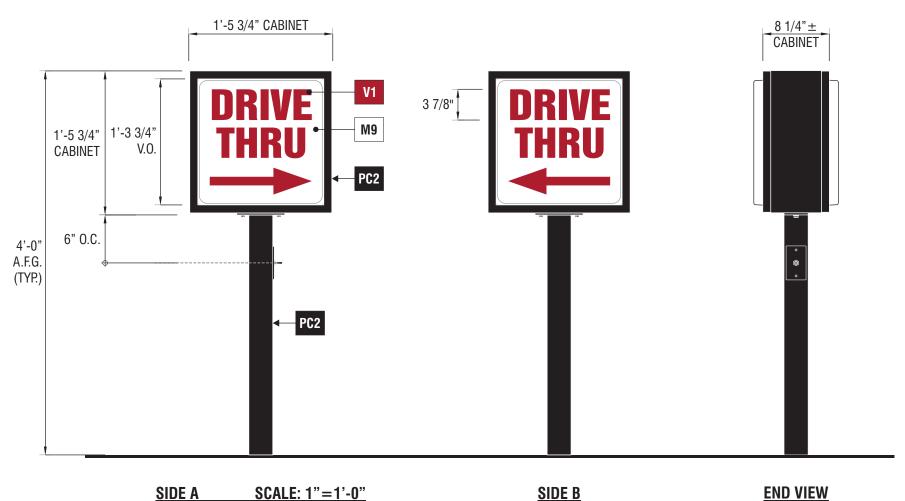

SCALE: 1"=1'-0"

(TYPICAL) 1'-5 3/4' 6500K WHITE LED MODULES -(1) 20W 12V **POWER SUPPLY** 1/4" PLATE / (2) 3/8" BOLTS 4'-0" OAH UL LISTED DISCONNECT TOGGLE SWITCH 2'-6 1/4" F.F.G. **SCALE:** 1"=1'-0" FOOTING PER ENGINEERING PRIMARY ELECTRICAL BY OTHERS-120 VOLT IN CONDUIT TO 1'-0" ABOVE GRADE WITH MIN. 36" EXCESS WIRE **POWDER COAT** 1'-6" FOOTING TYP. TO MATCH RAL 9004 'SIGNAL BLACK' W/ SATIN FINISH **SECTION AND FOOTING VIEW SCALE:** 1"=1'-0" **MATERIALS**

1'-5 3/4" CABINET

K1 K2 K3 SIGNTYPE JITB-DIR-17x17x48-DRIVETHRU-LEFT/RIGHT

2.3 SQ. FT.

MANUFACTURE AND INSTALL THREE (3) D/F INTERNALLY ILLUMINATED DIRECTIONAL SIGN(S)

CABINET: EXTRUDED ALUMINUM **POLE:** 3"x3" STEEL SQUARE TUBE

ILLUMINATION: LED - PRINCIPAL QWIK MOD 3 6500K WHITE

TABLE 11B-703.5.5 VISUAL CHARACTER HEIGHT

HEIGHT TO FINISH FLOOR OR GROUND FROM BASELINE OF CHARACTER	HORIZONTAL VIEWING DISTANCE	MINIMUM CHARACTER HEIGHT
	less than 72 inches (1829 mm)	⁵ / ₈ inch (<i>15</i> .9 <i>mm</i>)
40 inches (1016 mm) to less than or equal to 70 inches (1778 mm)	72 inches (1829 mm) and greater	⁵ / ₈ inch (15.9 mm), plus ¹ / ₈ inch (3.2 mm) per foot (305 mm) of viewing distance above 72 inches (1829 mm)
	less than 180 inches (4572 mm)	2 inches (51 mm)
Greater than 70 inches (1778 mm) to less than or equal to 120 inches (3048 mm)	180 inches (4572 mm) and greater	2 inches (51 mm), plus ¹ / ₈ inch (3.2 mm) per foot (305 mm) of viewing distance above 180 inches (4572 mm)
	less than 21 feet (6401 mm)	3 inches (76 mm)
greater than 120 inches (3048 mm)	21 feet (6401 mm) and greater	3 inches (76 mm), plus ¹ / ₈ inch (3.2 mm) per foot (305 mm) of viewing distance above 21 feet (6401 mm)



J4387 1240 W Wood St, Willows, CA 95988 USA Sales: Bob McCarter
Coordinator: Thea Tochihara
Design: JMc

Engineering:

date: 3/12/21 drawing: J4387-PERMIT revision: R4-9/6/23-JMc project ID: JIB_4387_2

1 1/4"¬__<u>8 1/4"±</u>

FORMED FACE

CABINET


END VIEW
SCALE: 1"=1'-0"

16

M9 .093" WHITE LEXAN

VINYL

3M 3630-73 'DARK RED'

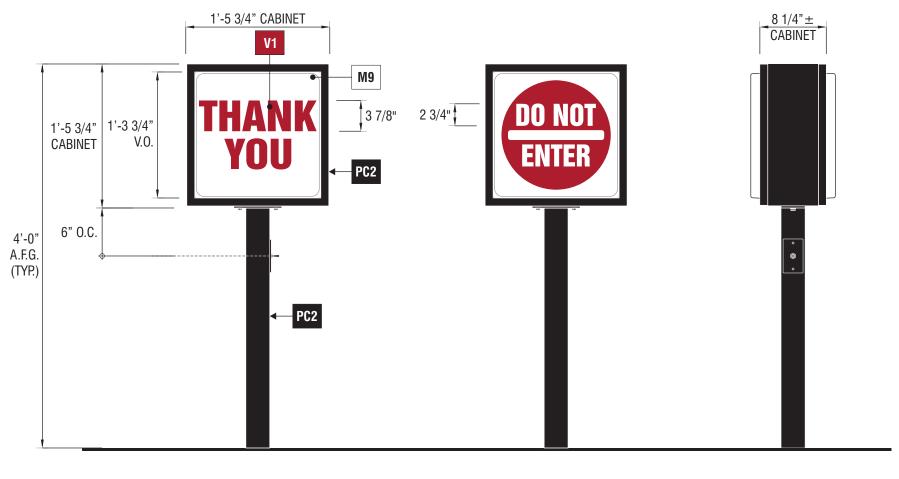

SIDE A SCALE: 1"=1'-0" 2.3 SQ. FT.

SIDE B SCALE: 1"=1'-0"

END VIEW SCALE: 1"=1'-0"

SIGNTYPE JITB-DIR-17x17x48-THANKYOU/DONOTENTER

MANUFACTURE AND INSTALL ONE (1) D/F INTERNALLY ILLUMINATED DIRECTIONAL SIGN(S)

CABINET: EXTRUDED ALUMINUM POLE: 3"x3" STEEL SQUARE TUBE

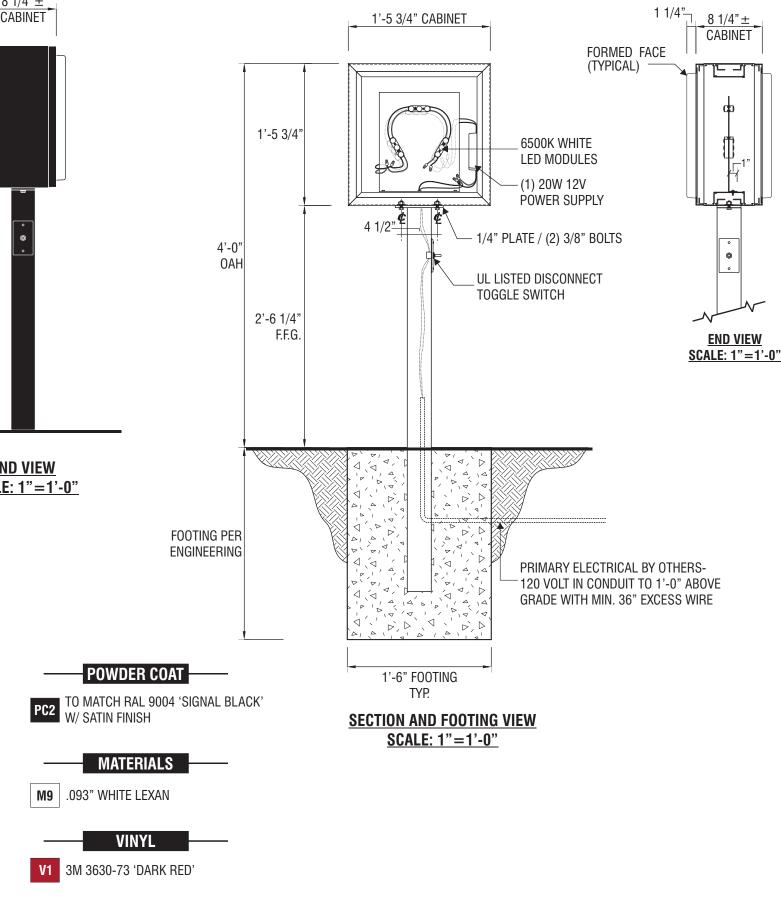
ILLUMINATION: LED - PRINCIPAL QWIK MOD 3 6500K WHITE

TABLE 11B-703.5.5 VISUAL CHARACTER HEIGHT

HEIGHT TO FINISH FLOOR OR GROUND FROM BASELINE OF CHARACTER	HORIZONTAL VIEWING DISTANCE	MINIMUM CHARACTER HEIGHT
	less than 72 inches (1829 mm)	⁵ / ₈ inch (<i>15.9 mm</i>)
40 inches (1016 mm) to less than or equal to 70 inches (1778 mm)	72 inches (1829 mm) and greater	⁵ / ₈ inch (15.9 mm), plus ¹ / ₈ inch (3.2 mm) per foot (305 mm) of viewing distance above 72 inches (1829 mm)
	less than 180 inches (4572 mm)	2 inches (51 mm)
Greater than 70 inches (1778 mm) to less than or equal to 120 inches (3048 mm)	180 inches (4572 mm) and greater	2 inches (51 mm), plus ¹ / ₈ inch (3.2 mm) per foot (305 mm) of viewing distance above 180 inches (4572 mm)
	less than 21 feet (6401 mm)	3 inches (76 mm)
greater than 120 inches (3048 mm)	21 feet (6401 mm) and greater	3 inches (76 mm), plus ¹ / ₈ inch (3.2 mm) per foot (305 mm) of viewing distance above 21 feet (6401 mm)

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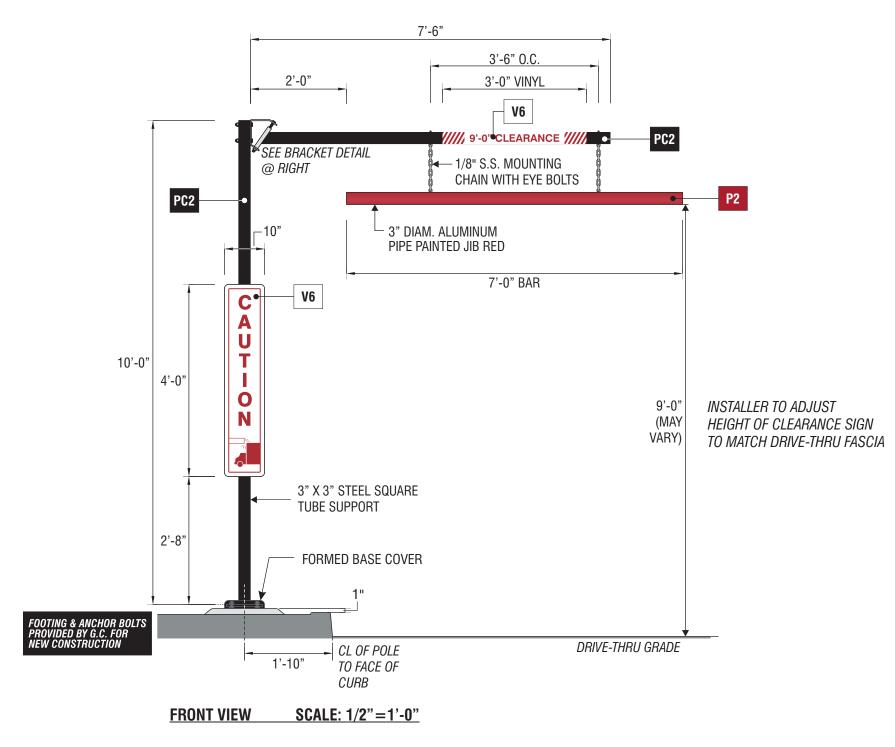


JACK IN THE BOX

J4387 1240 W Wood St, Willows, CA 95988 USA

Sales: Bob McCarter **Coordinator:** Thea Tochihara Design: JMc

Engineering:



POWDER COAT PC2 TO MATCH RAL 9004 'SIGNAL BLACK' W/ SATIN FINISH TO MATCH MP 64691 'JIB RED' P2 W/ SATIN FINISH

FABRICATED ALUMINUM CAP

(1/16" LIP)

1/2" STAINLESS

STEEL THRU

BOLT (TYP.)

7 3/4"

VINYL

3M WHITE REFLECTIVE VINYL (680-10) W/ PMS 200 PRINTED COPY

L1 L2 SIGNTYPE JITB-H-BAR-120

MANUFACTURE AND INSTALL ONE (1) HEIGHT DETECTOR

POLE: 3"x3" STEEL SQUARE TUBE ARM: 3"x1" STEEL RECTANGULAR TUBE

POLE 'CAUTION' PANEL: .063" PRE-COATED WHITE ALUMINUM

4444 Federal Blvd San Diego, CA 92102 (619) 527-6100 signtech.com



JACK IN THE BOX

1240 W Wood St. Willows, CA 95988 USA

Sales: Bob McCarter **Coordinator:** Thea Tochihara

BRACKET DETAIL

drawing: J4387-PERMIT revision: R4-9/6/23-JMc Design: JMc project ID: JIB_4387_2 **Engineering:**

date: 3/12/21

6 11/16"

-WASHER

SCALE: 3"=1'-0"

3/8" X 2 1/2"

BAR BRACKET

STAINLESS STEEL FLAT

3/16

-5/8" DIAM. STAINLESS

STEEL BOLT (9" LONG)

3/4" DIAM. STAINLESS

-3" H X 1" DP. BLACK

COPE TO INSET 3/4" STAINLESS TUBE.

STEEL TUBE.

TUBE

Design Review Analysis

Design Review (DR-24-04) & Use Permit (UP-24-06)

1240 W. Wood Street/APNs: 001-041-014 & 001-041-015

I. Introduction

This Design Review Analysis (Analysis) evaluates the proposed exterior design for the proposed building to be located at 1240 W. Wood Street, identified by Assessor Parcel Numbers (APNs): 001-041-014 and - 015. The Analysis focuses on the project's compliance with design review criteria, including building design, site relationship, neighborhood compatibility, material selection, site improvements, and operational considerations.

II. Design Review Analysis

Competent Design

The proposed building has been designed by professional architects/engineers licensed within the State of California to meet the building code standards of development. The single-story building will have parapets to screen the rooftop where the mechanical equipment will be located. The height of the building with the parapet ranging from 20 to 23 feet high.

Relationship Between Structures Within the Development and Between Structures and Site

The new building will be placed along the southeastern side of the parcels and visible from W. Wood Street. WMC Section 18.141.060(3) states that "The design shall show that due regard has been given to orientation of structures to streets, climatic considerations, and especially, the creation and utilization of open space." Placing the building along the eastern property line allows for a larger open space for parking and landscaping. There are no awnings on the western side of the building, only a cover over the entrance.

Relationship between Development and Neighborhood

The addition of a 2,739-square-foot (sf) commercial building will not be out of character for the neighborhood, as commercial uses surround this property. Surrounding properties to the north, west, and south, are similar zoned as Highway Commercial as the Site and the property to the west is zoned as Entryway (E). The surrounding visual characteristics consists of the following:

- North: Immediately north of the Site is W. Wood Street followed by Valley Auto Wash, an asymmetrical beige building, and O'Reilly Auto Parts, a rectangular building, in red, green, and crème. Both properties feature decorative landscaping.
- West: To the west of the Site is the rear of the main building for Chevron, a rectangular white and grey wall, surrounded by landscaping.
- South: South of the Site is an undeveloped vacant lot.
- East: West of the property is a car wash with a simple, rectangular structure with blue roof and white walls on a paved concrete lot.

Materials and Colors Used

The new building will have an exterior cement plaster sand finish with the main body color of a "Quartz Grey" color and a "Mindful Grey" color, both on the softer brown/grey scheme. The bottom of the building will have an accent color of "Black Fox" a darker brown color, with another accent element used on approximately one-third of the building, a porcelain tile-like look which will be a "Sweet Georgia Brown" color. Another accent color used in places on the building is "Red Bay" a deeper red/brown color. The top edge of the building will have aluminum coping in the Quartz Grey color. Corrugated wall panels in the red bay color are mixed in with the areas using this accent color.

Wall and Fencing

No new walls or fences around the property perimeter are proposed with this project. An enclosed trash receptacle is included on the Site, located in the far southern portion of the lot area and will be screened and enclosed with a gate. All waste and recycling including cardboard will be in a secured, screened space. The trash hauler was concerned of drive through stacking causing a problem with them getting to the enclosure. However, given the layout of the site there is sufficient room for movement of their vehicles and still allowing the users access to the drive-through area. A loading zone is provided for delivery of goods and equipment.

Surface Water Drainage

All surface/on-site water shall drain properly. WMC Section 18.141.030 states that "Stormwaters shall be removed and carried away in an adequate drainage system". Surface water and all paved areas shall be collected at intervals so that it will not obstruct the flow of vehicles or pedestrian traffic and will not create puddles on the paved areas. The project is conditioned as such within the Engineering Department section of Attachment 2 of the Staff Report.

Drives, Parking and Circulation

Access to the project site will be provided by one of two driveways located along W. Wood Street. Parking will be provided for all uses per Municipal Code Section 18.120.020(10)(c) which requires the higher of one parking space for each 200 square feet of gross floor area or one parking space for every four seats, and one parking space for every two employees. According to the proposed restaurant design, there will be 64 indoor seats. Using the seat calculation, the minimum required parking spaces would require sixteen (16) parking spaces plus four (4) for the employees for a total of twenty (20) spaces. The proposed development plan includes a total of 30 parking spaces, which exceeds the minimum requirement of twenty (20) spaces.

Utility Service

All new utilities shall be placed underground as conditioned by the Engineering Department. Please see Attachment 2 of the Staff Report.

<u>Signs</u>

The sign plans submitted did not propose a pole sign, however staff was informed recently that they intend to install one. This can be part of the conditions. This project will install other new signage to advertise and sell their products. More discussion on signage under Use Permit, as the proposed amount of incidental signage exceeds the allotted amount per the sign code.

Exterior Lighting

Lighting will be installed on the Site. WMC Section 18.141.060(10) states "Light sources shall not create a glare or hazard on adjoining streets or be annoying to adjacent properties or residential areas". Exterior building wall fixtures will be installed on the building and are required to be downcast. LED pole light standards will be located in the parking lot. As a condition of approval, photometric plan shall be submitted for review to ensure that lighting will not be over glaring and/or project onto adjacent property.

Landscaping

Landscaping is proposed for the Site to include trees, shrubs and ground cover, which will border the entire site. Trees will be placed in the parking areas in order to provide future shade for users.

III. Conclusion

Per Section 18.141.070(1), an application for design review may be approved, approved with modifications, conditionally approved, or disapproved.

Site Photos

2018



Former Bldg on back lot



Former buildings on front lot



Looking north



Looking south across Wood Street



COMMENTS AND REPORTS